

**LEGEND**

- RED LINE BOUNDARY
- FLOOD DEFENCE
- FLOOD GATE
- NEW ROAD
- NEW BUILDING
- NEW UNDERGROUND STRUCTURE
- ELEVATION SECTIONS
- PROPOSED GAS TURBINE LAYOUT
- PROPOSED PLANT
- PALISADE FENCE

- NOTES**
1. TO BE PRINTED AT A0
  2. GROUND LEVELS ARE IN METRES RELATIVE TO ORDNANCE DATUM POOLBEG (ODP)

**DRAWN BY**  
CONOR COONEY


**ISSUE/REVISION**

I/R	DATE	DESCRIPTION
B	22/11/2023	FOR PLANNING
A	03/10/2023	FOR COMMENT
I/R	DATE	DESCRIPTION

**PROJECT NUMBER**  
60695232

**SHEET TITLE**  
Proposed Site Elevations  
Elevations Site Plan  
Sheet 1 of 9

**SHEET NUMBER**  
60695232-TBT-DR-002B

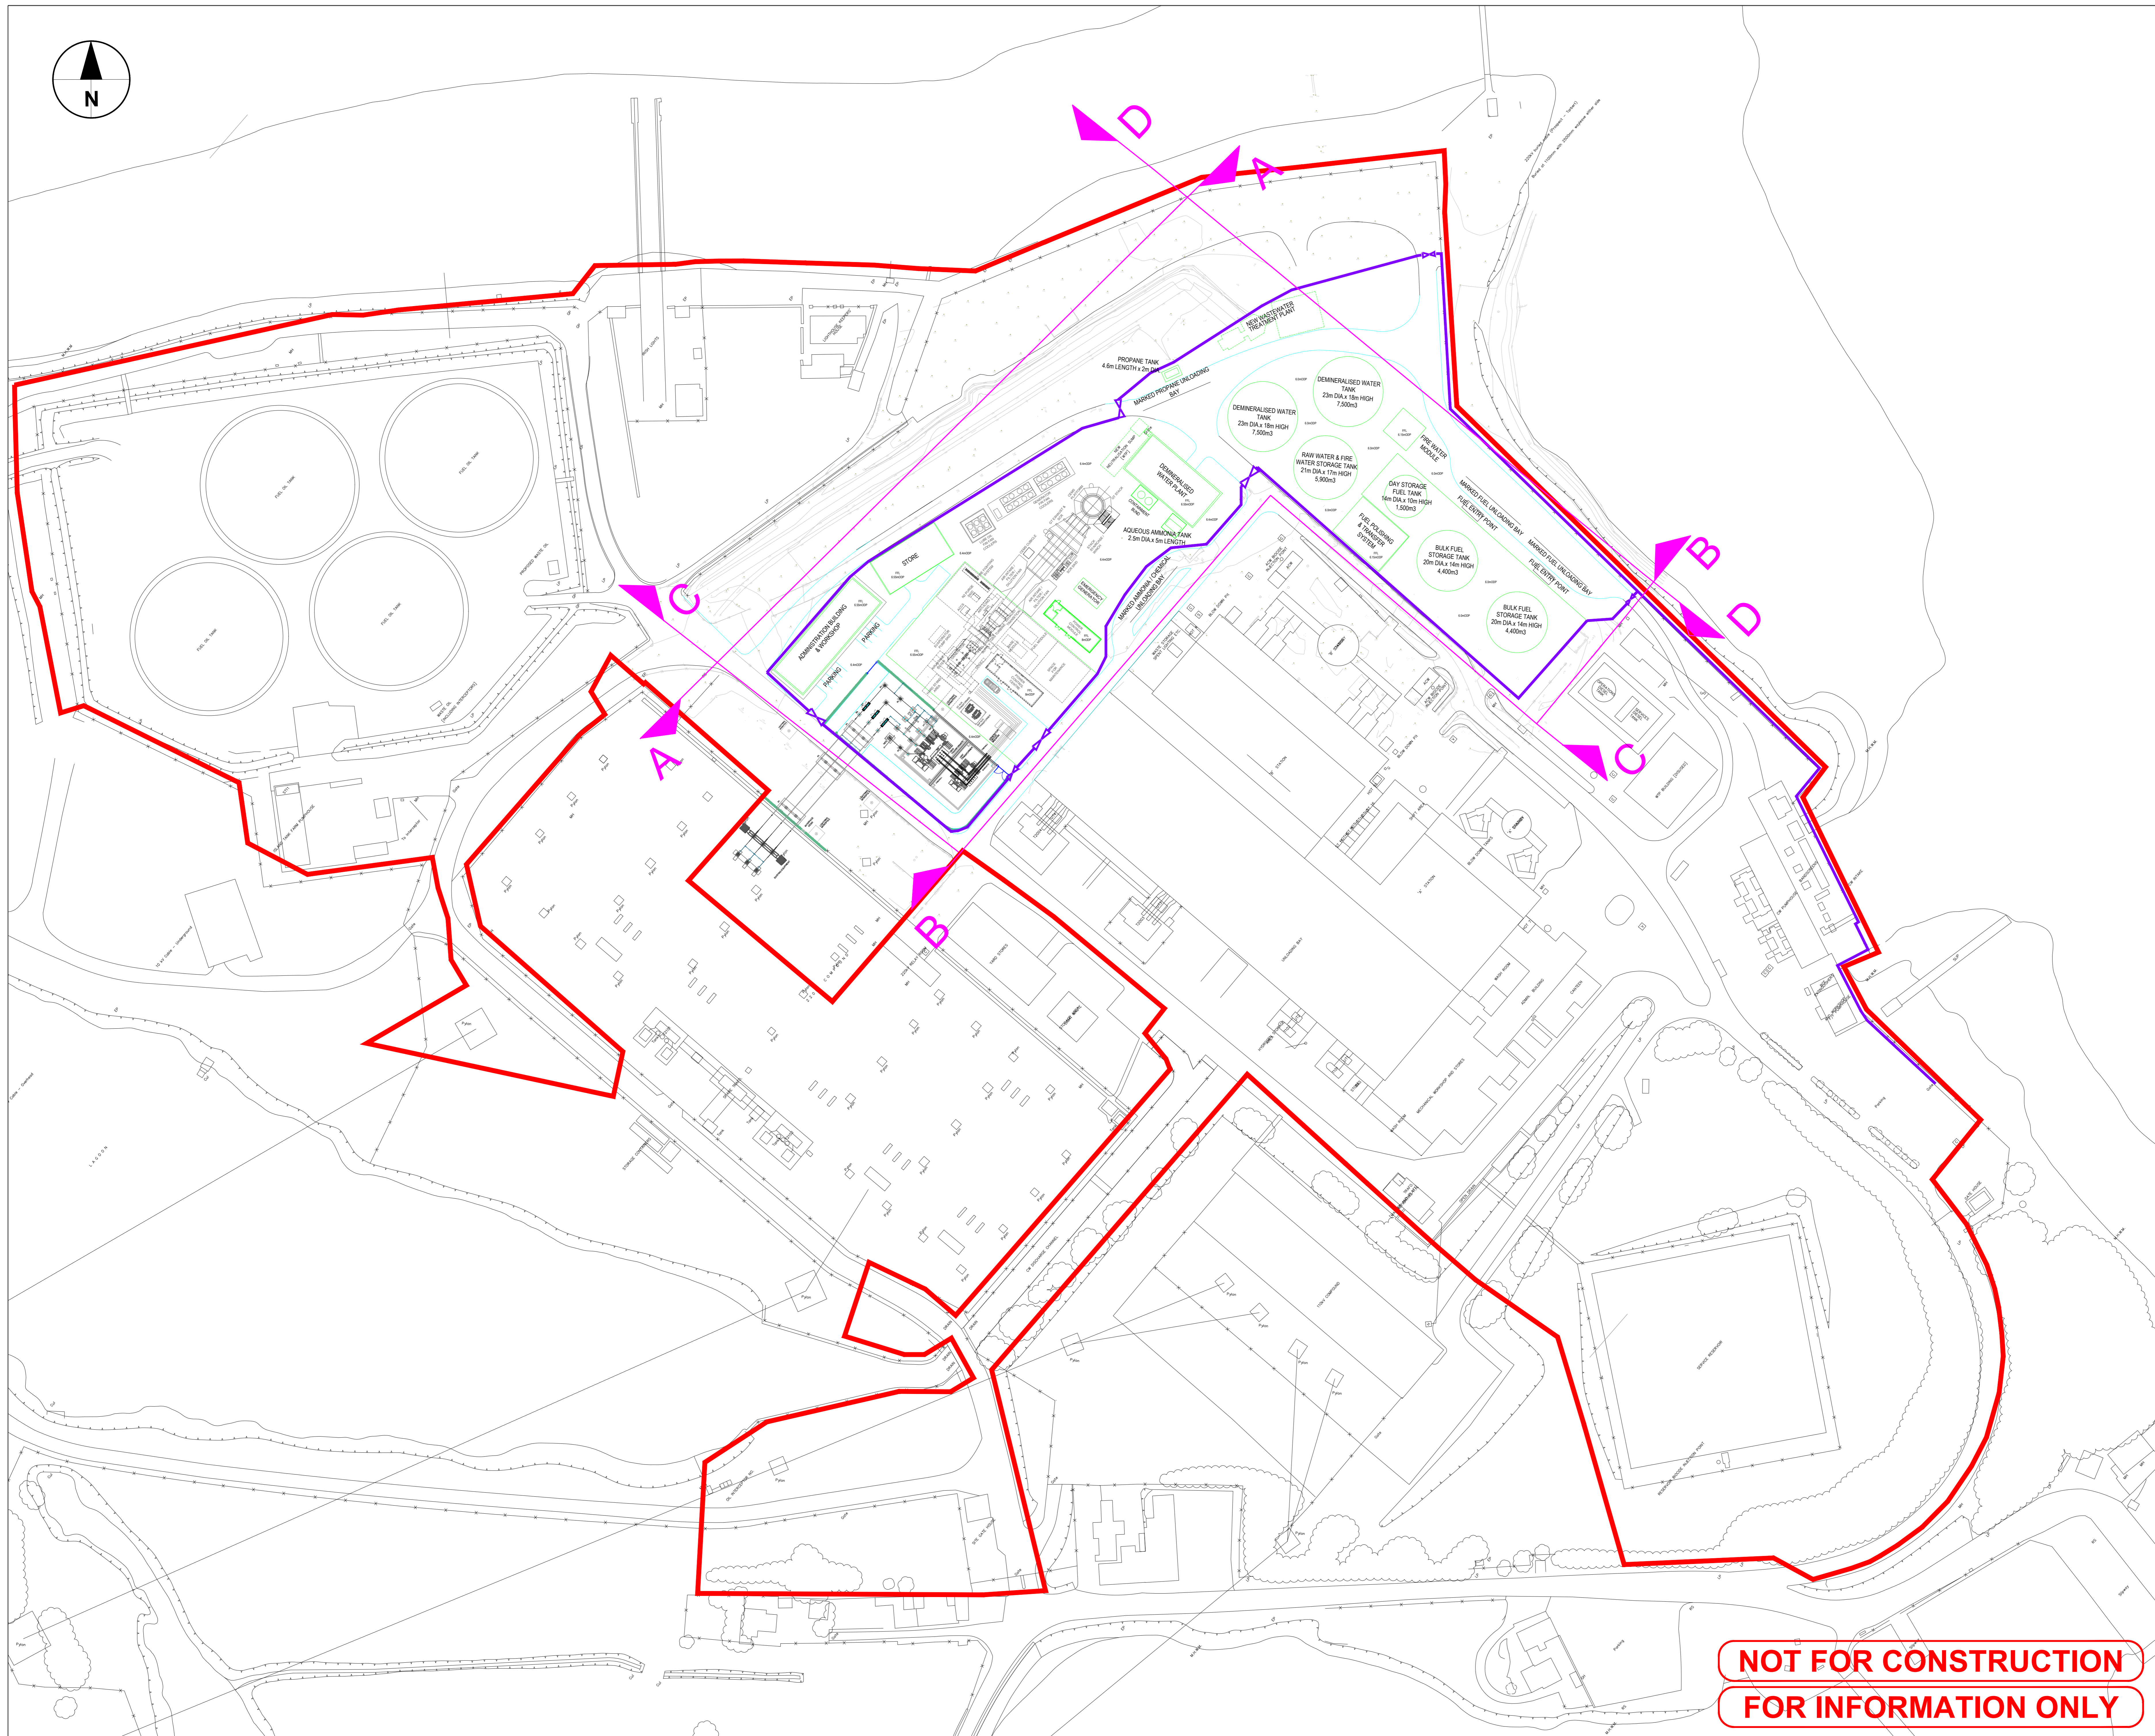


**NOT FOR CONSTRUCTION  
FOR INFORMATION ONLY**

This drawing has been prepared for the use of AECOM's client. It may not be used, modified, reproduced or relied upon by third parties, except as agreed by AECOM or as required by law. AECOM accepts no responsibility, and denies any liability, whatsoever, to any party that uses or relies on this drawing without AECOM's express written consent. Do not scale this document. All measurements must be obtained from the stated dimensions.

ISSUE/REVISION		
I/R	DATE	DESCRIPTION
B	22/11/2023	FOR PLANNING
A	03/10/2023	FOR COMMENT

## ELEVATION A-A



SCALE 1:400

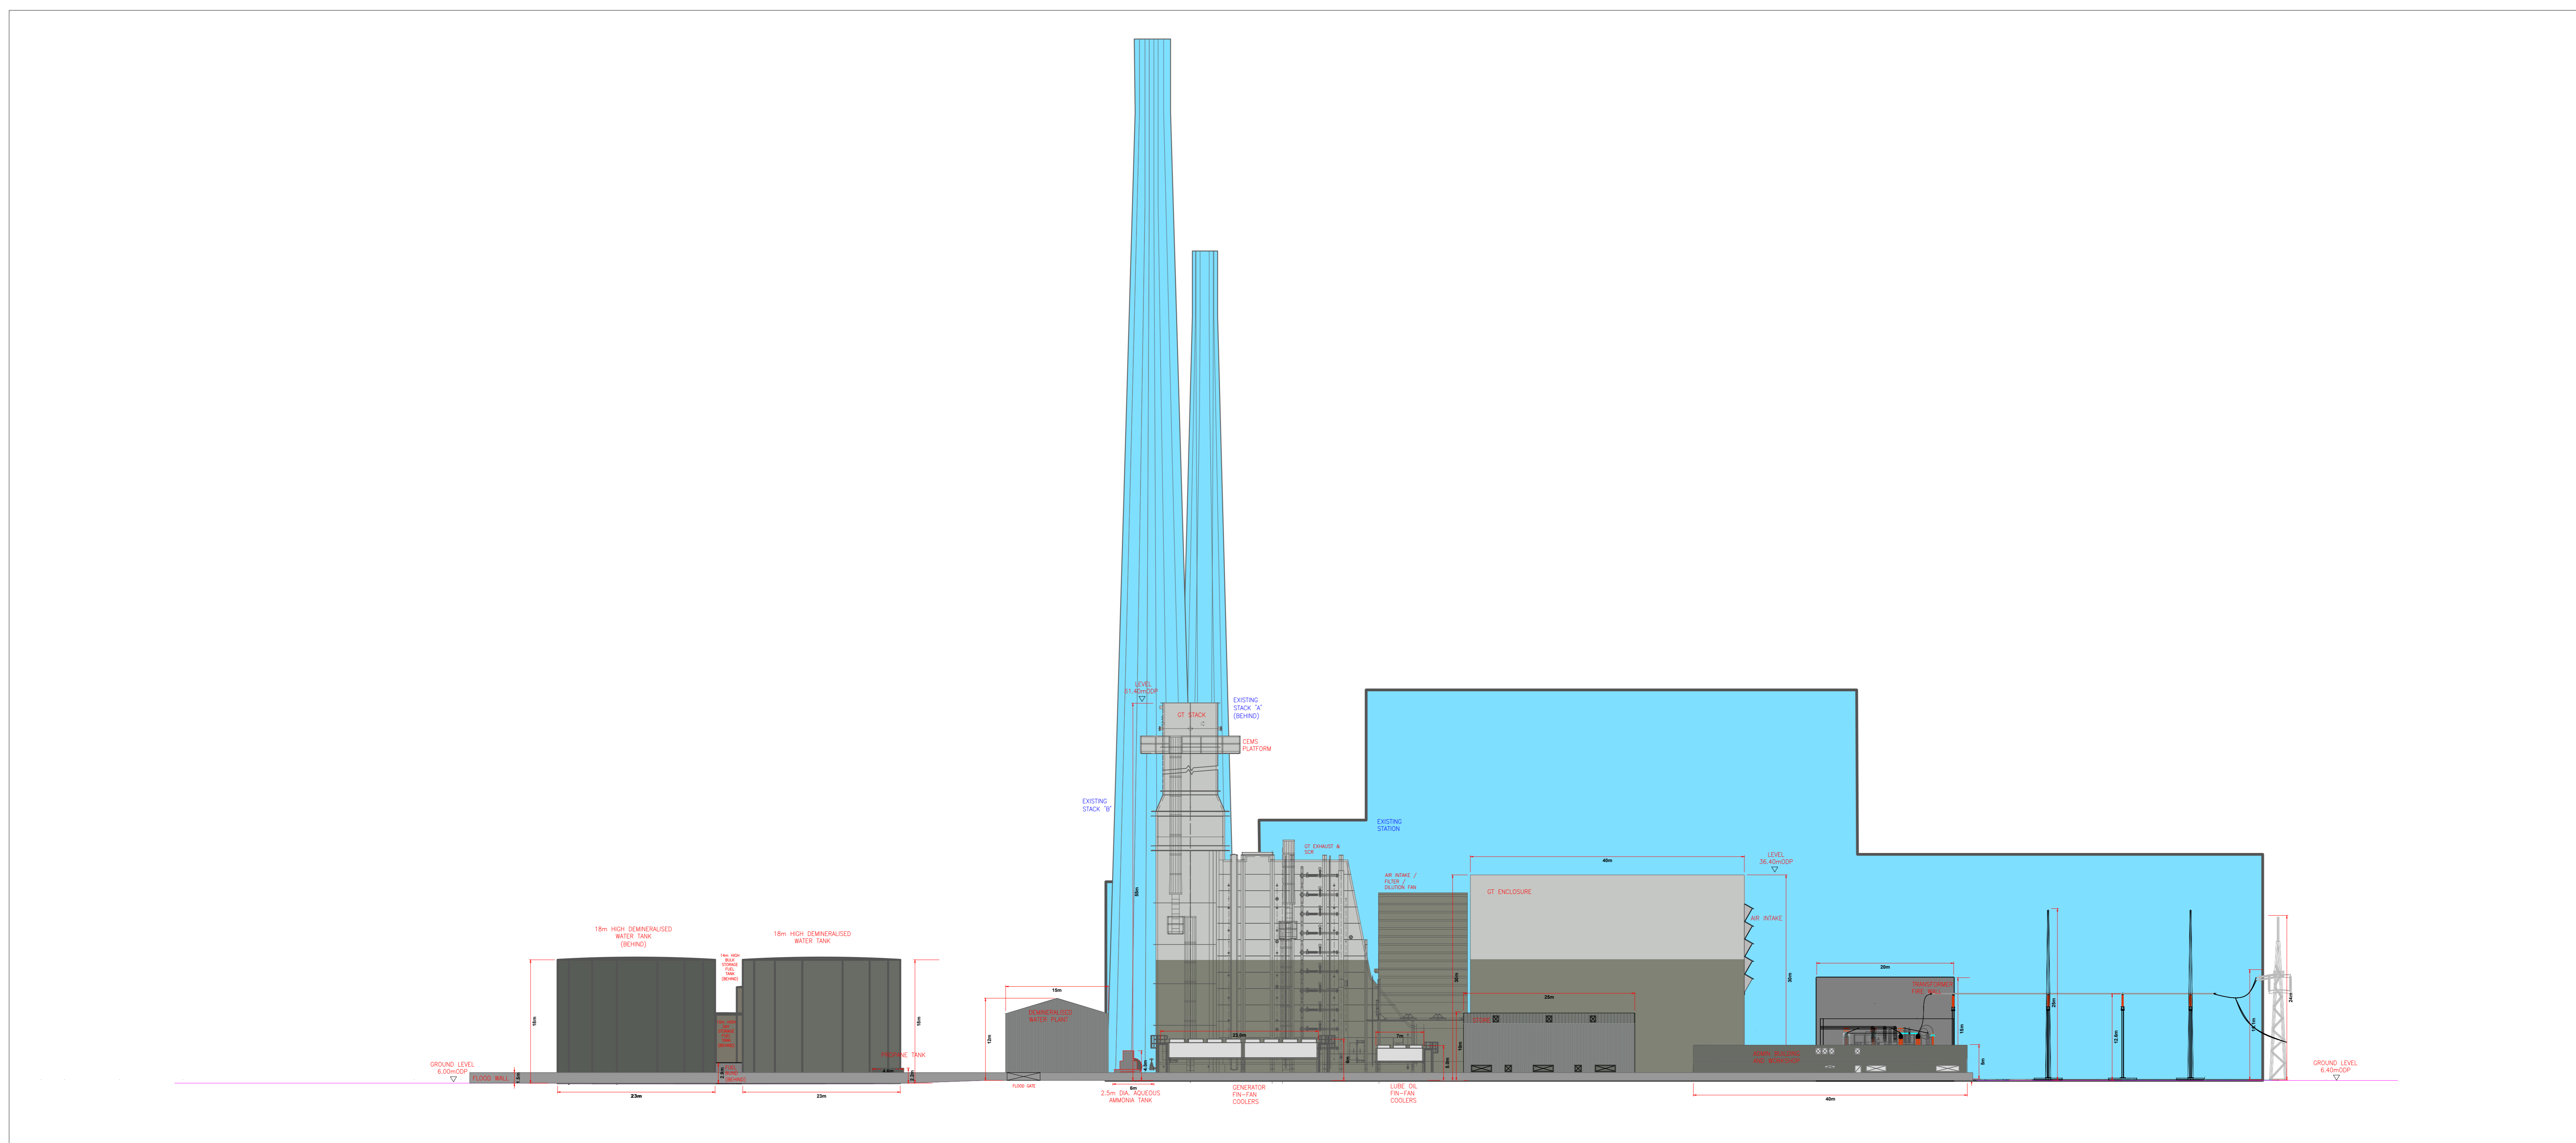

This drawing has been prepared for the use of AECOM's client. It may not be used, modified, reproduced or relied upon by third parties, except as agreed by AECOM or as required by law. AECOM accepts no responsibility, and denies any liability, whatsoever, to any party that uses or relies on this drawing without AECOM's express written consent. Do not scale this document. All measurements must be obtained from the stated dimensions.

# ELEVATION A-A

SCALE 1:200

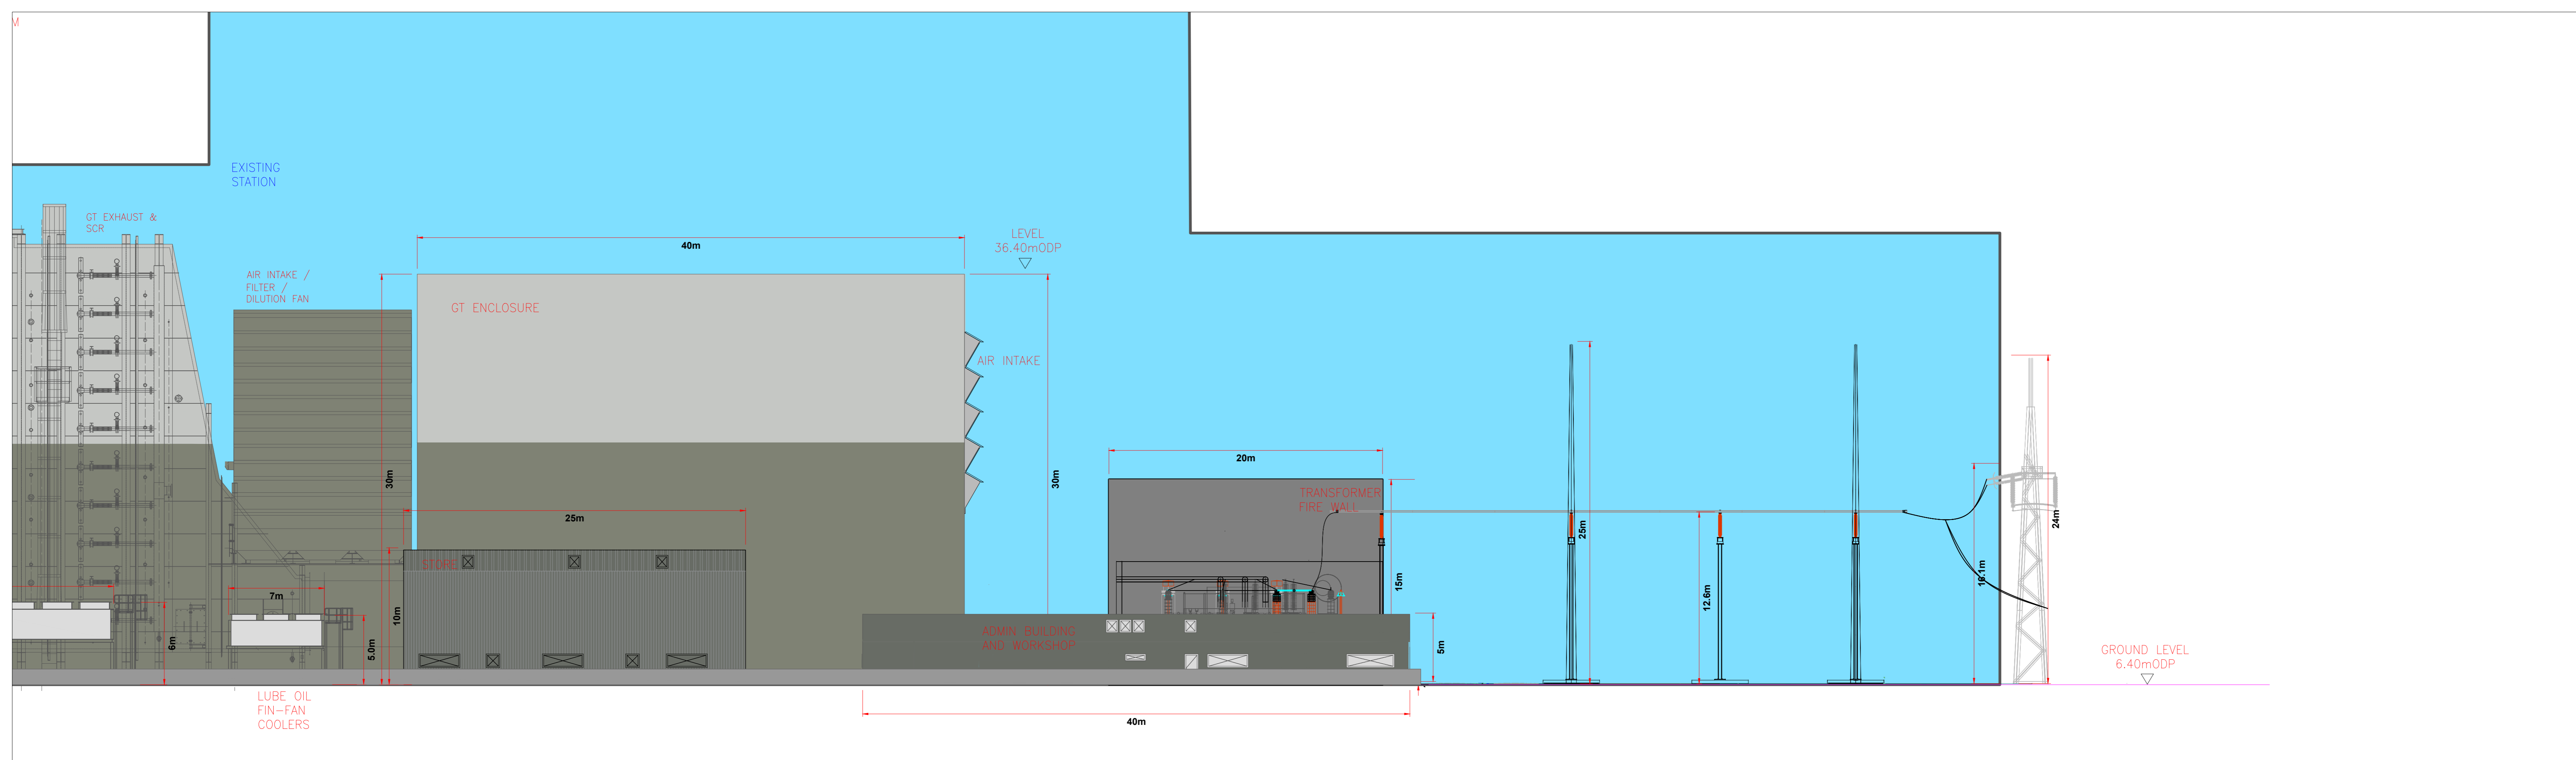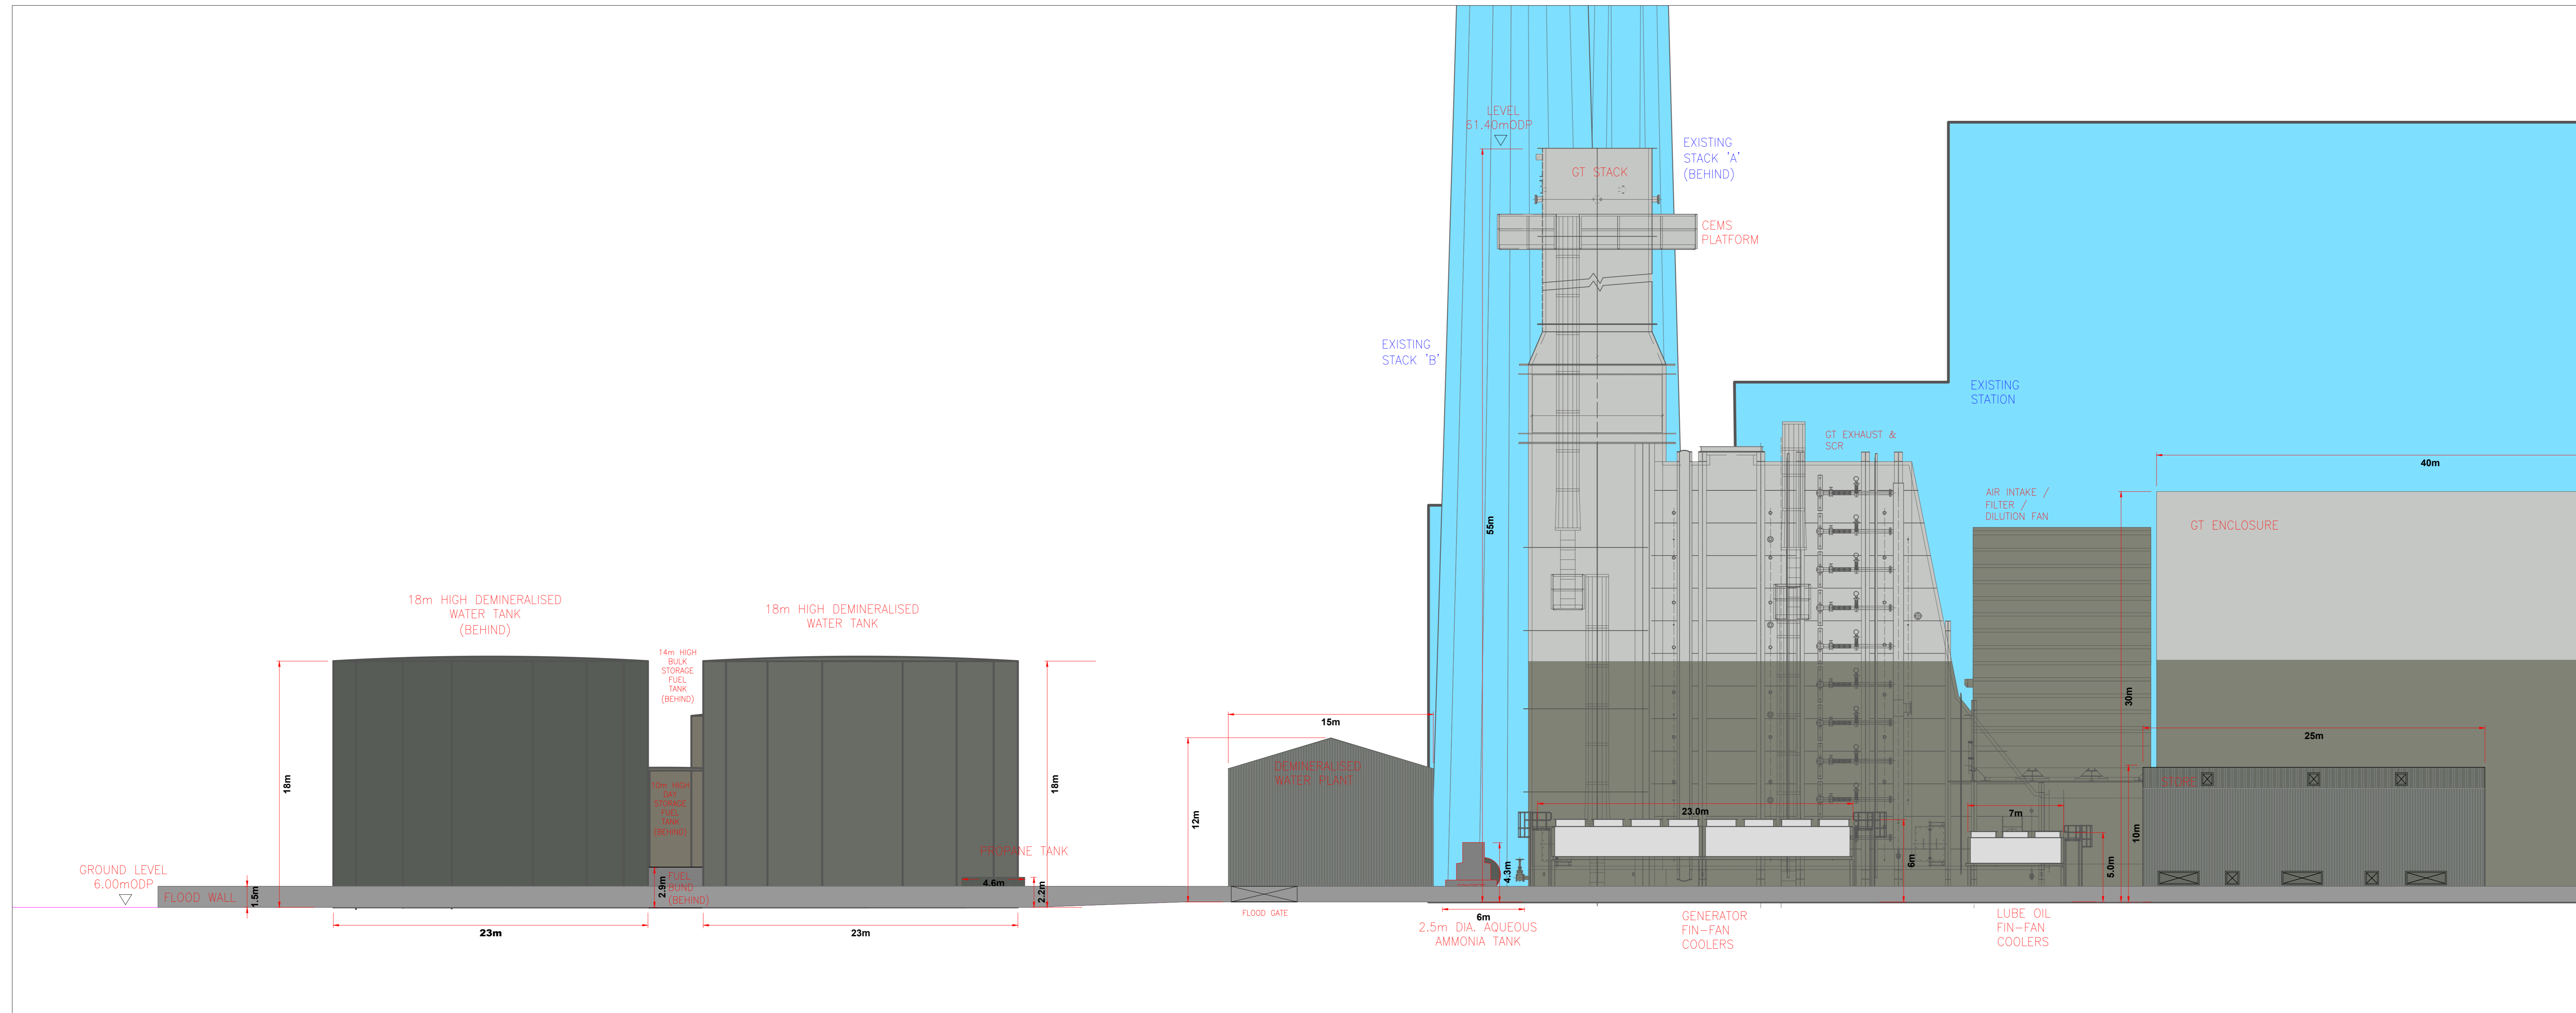


PROJECT  
**TARBERT NEXT  
 GENERATION POWER  
 STATION**

CLIENT  
**SSE GENERATION  
 IRELAND LTD**

CONSULTANT  
 AECOM  
 2ND FLOOR, 177 BOTHWELL STREET  
 GLASGOW G2 7ER  
 +44 (0) 141 202 0500  
 www.AECOM.com

LEGEND  
 EXISTING STRUCTURE

- NOTES
1. PROPOSED ELEVATIONS ARE RELATIVE TO ORDNANCE DATUM POOLBEG
  2. TO BE PRINTED AT A0

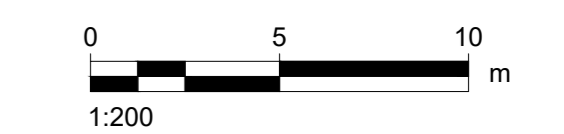

DRAWN BY  
 CONOR COONEY

ISSUE/REVISION		
I/R	DATE	DESCRIPTION
B	22/11/2023	FOR PLANNING
A	03/10/2023	FOR COMMENT

PROJECT NUMBER  
 60695232



SHEET TITLE  
 Proposed Site Elevations  
 Elevation A-A  
 Sheet 3 of 9

SHEET NUMBER  
 60695232-TBT-DR-002B

This drawing has been prepared for the use of AECOM's client. It may not be used, modified, reproduced or relied upon by third parties, except as agreed by AECOM or as required by law. AECOM accepts no responsibility, and denies any liability, whatsoever, to any party that uses or relies on this drawing without AECOM's express, written consent. Do not scale this document. All measurements must be obtained from the stated dimensions.

## ELEVATION B-B

SCALE 1:400

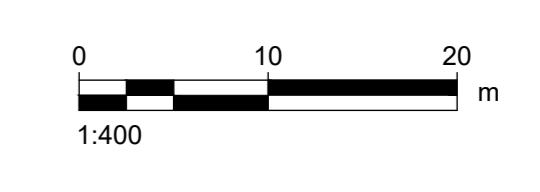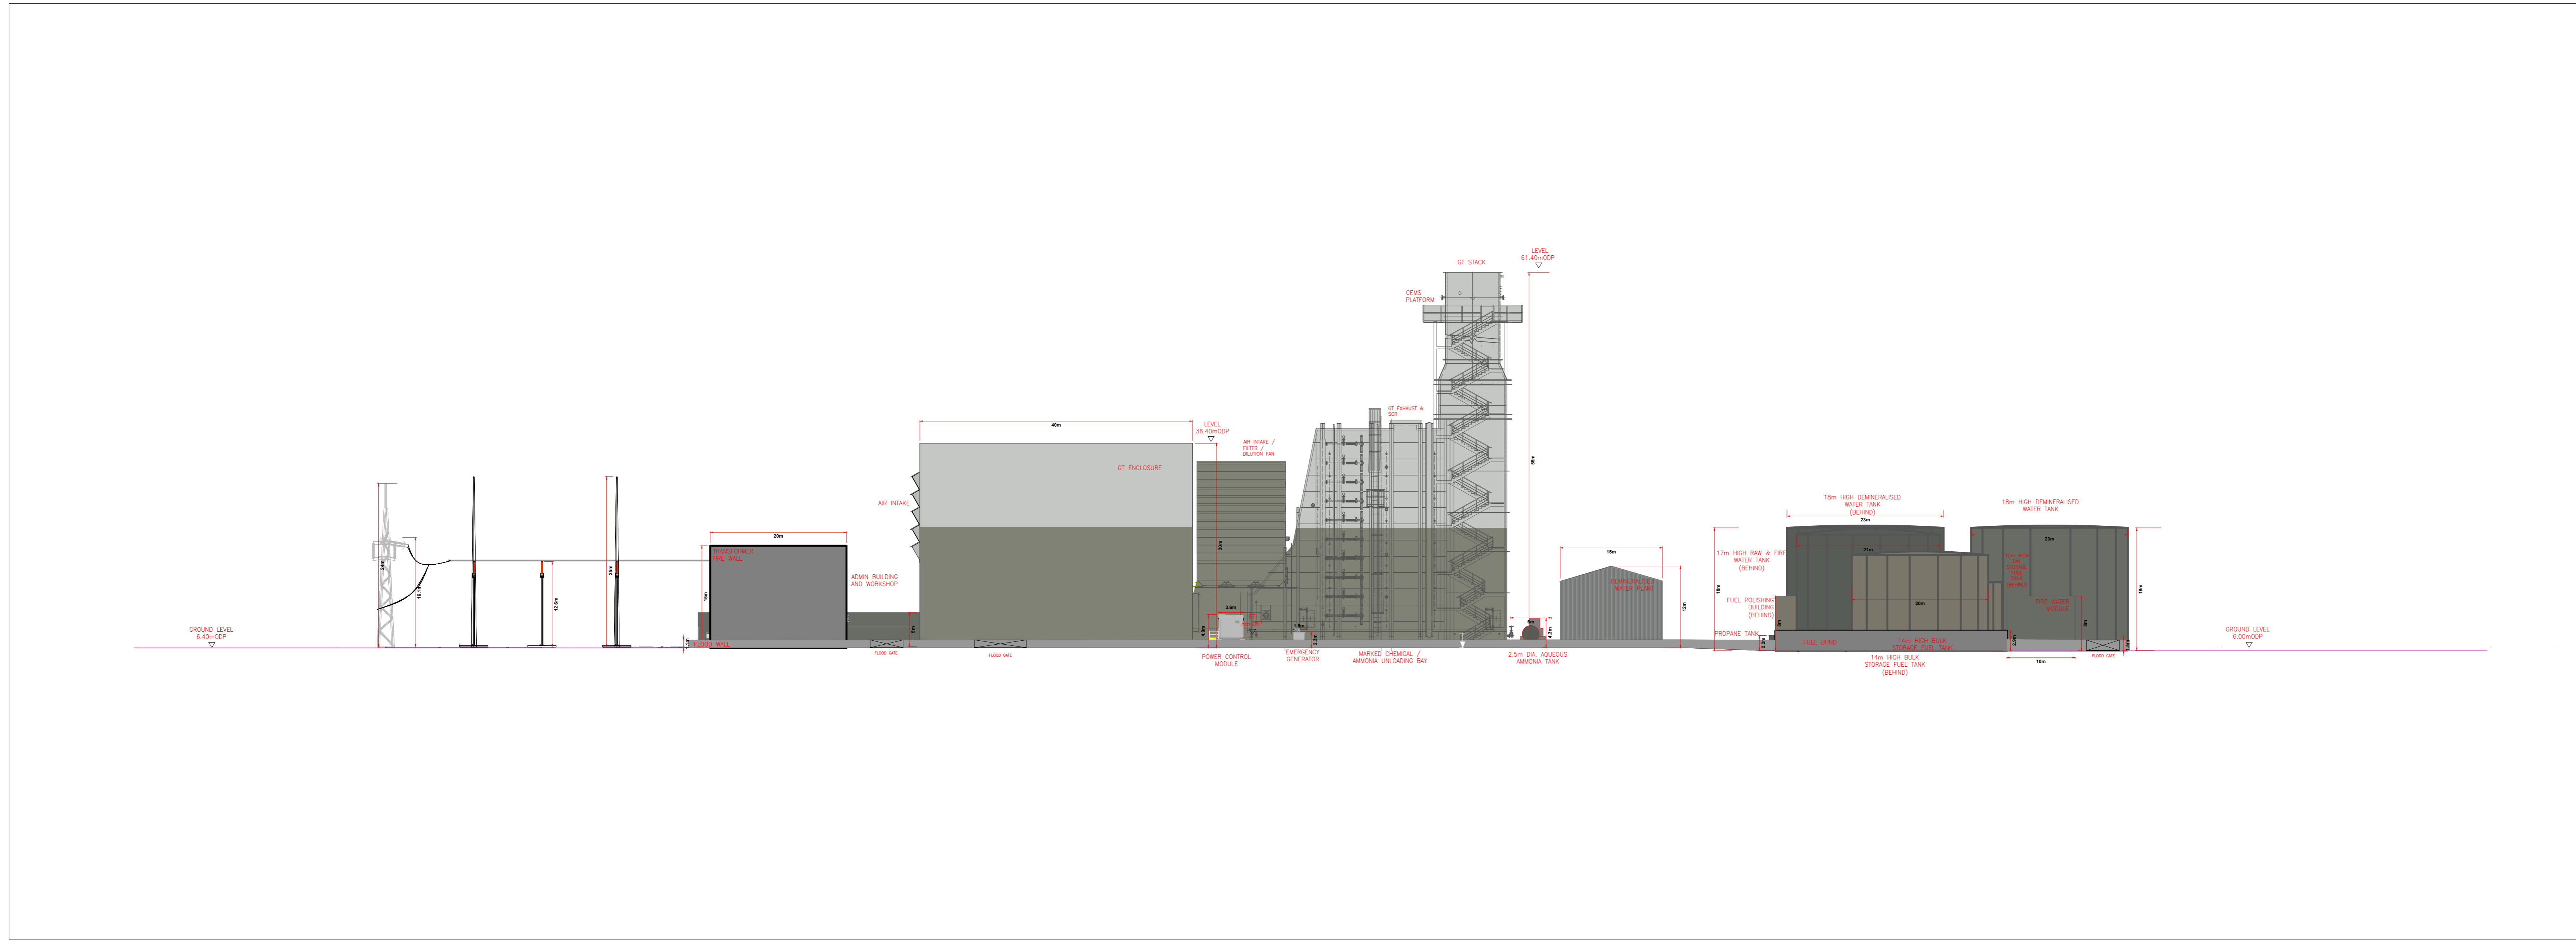

**DRAWN BY**  
 CONOR COONEY

**ISSUE/REVISION**

I/R	DATE	DESCRIPTION
B	22/11/2023	FOR PLANNING
A	03/10/2023	FOR COMMENT

**PROJECT NUMBER**  
 60695232



**SHEET TITLE**  
 Proposed Site Elevations  
 Elevation B-B  
 Sheet 4 of 9

**SHEET NUMBER**  
 60695232-TBT-DR-002B


This drawing has been prepared for the use of AECOM's client. It may not be used, modified, reproduced or relied upon by third parties, except as agreed by AECOM or as required by law. AECOM accepts no responsibility, and denies any liability, whatsoever, to any party that uses or relies on this drawing without AECOM's express written consent. Do not scale this document. All measurements must be obtained from the stated dimensions.

# ELEVATION B-B

SCALE 1:200

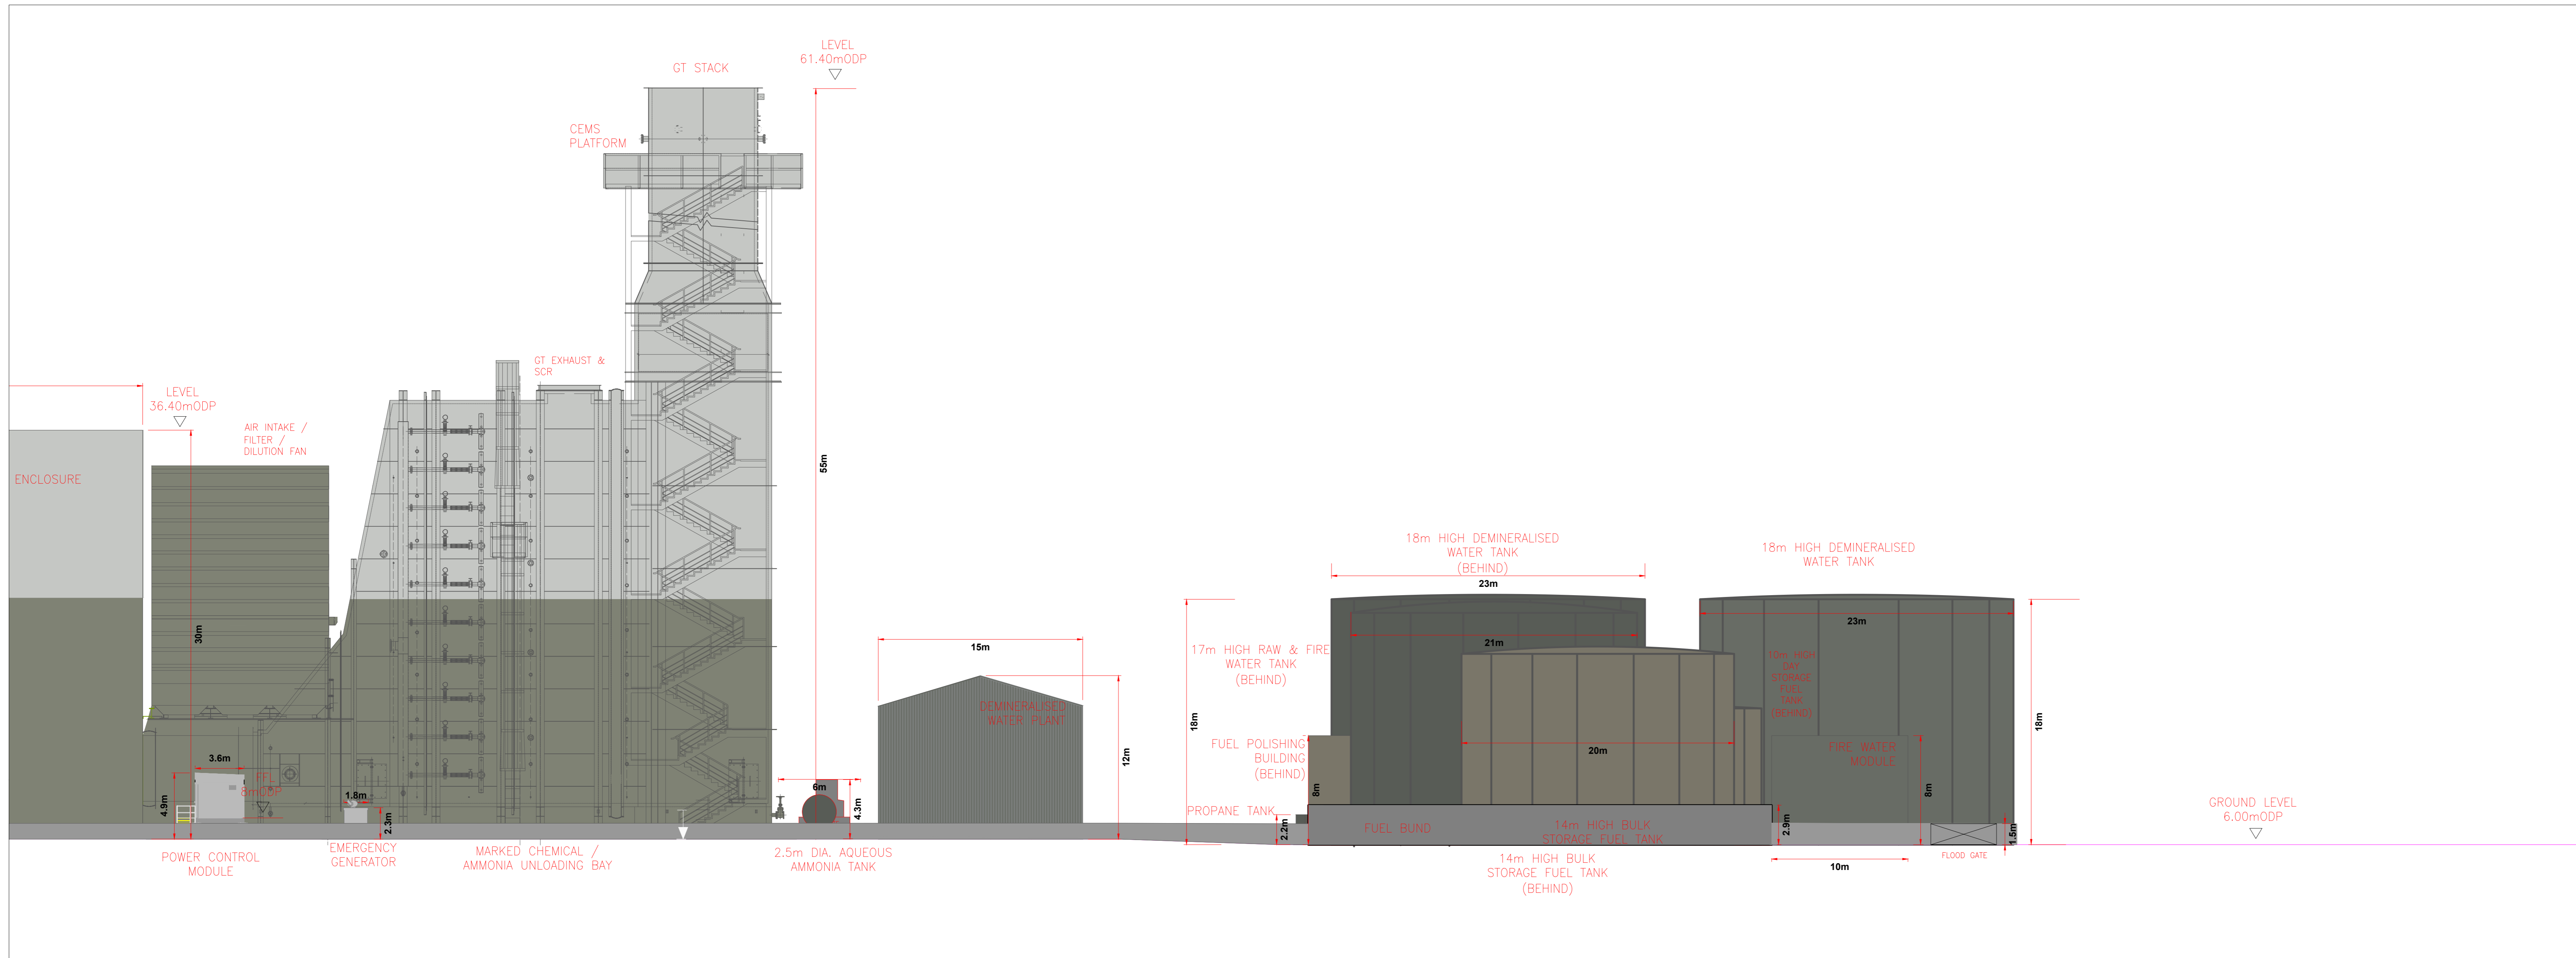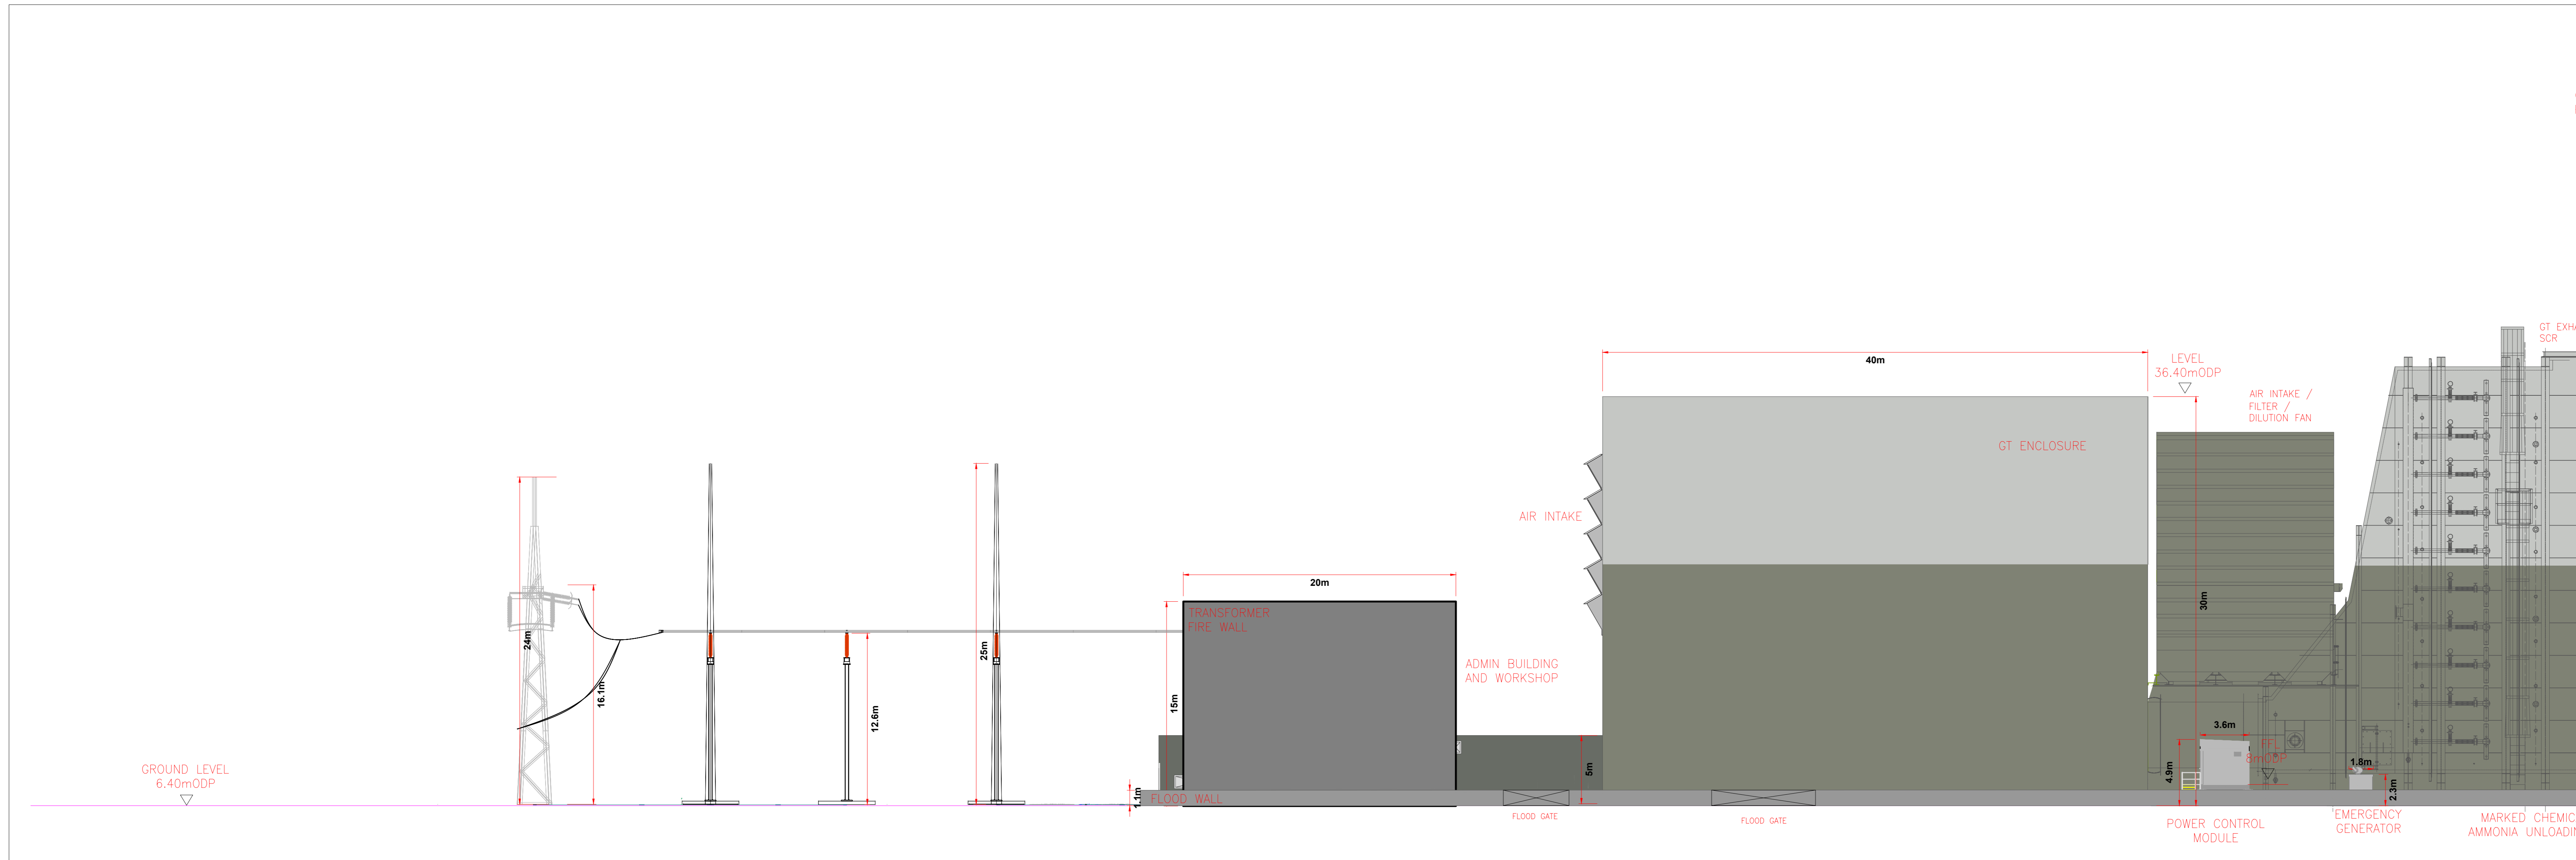

- NOTES
1. PROPOSED ELEVATIONS ARE RELATIVE TO ORDNANCE DATUM POOLBEG
  2. TO BE PRINTED AT A0

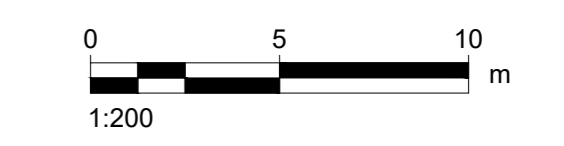

DRAWN BY  
 CONOR COONEY

ISSUE/REVISION		
NO	DATE	DESCRIPTION
B	22/11/2023	FOR PLANNING
A	03/10/2023	FOR COMMENT
I/R	DATE	DESCRIPTION

PROJECT NUMBER  
 60695232

SHEET TITLE  
 Proposed Site Elevations  
 Elevation B-B  
 Sheet 5 of 9

SHEET NUMBER  
 60695232-TBT-DR-002B

This drawing has been prepared for the use of AECOM's client. It may not be used, modified, reproduced or relied upon by third parties, except as agreed by AECOM or as required by law. AECOM accepts no responsibility, and denies any liability, whatsoever, to any party that uses or relies on this drawing without AECOM's express, written consent. Do not scale this document. All measurements must be obtained from the stated dimensions.

1. PROPOSED ELEVATIONS ARE RELATIVE TO ORDNANCE DATUM POOLBEG
2. TO BE PRINTED AT A0



CONOR COONEY

I/R	DATE	DESCRIPTION
B	22/11/2023	FOR PLANNING
A	03/10/2023	FOR COMMENT


60695232

Proposed Site Elevations  
Elevation C-C  
Sheet 6 of 9

60695232-TBT-DR-002B

## ELEVATION C-C



SCALE 1:400

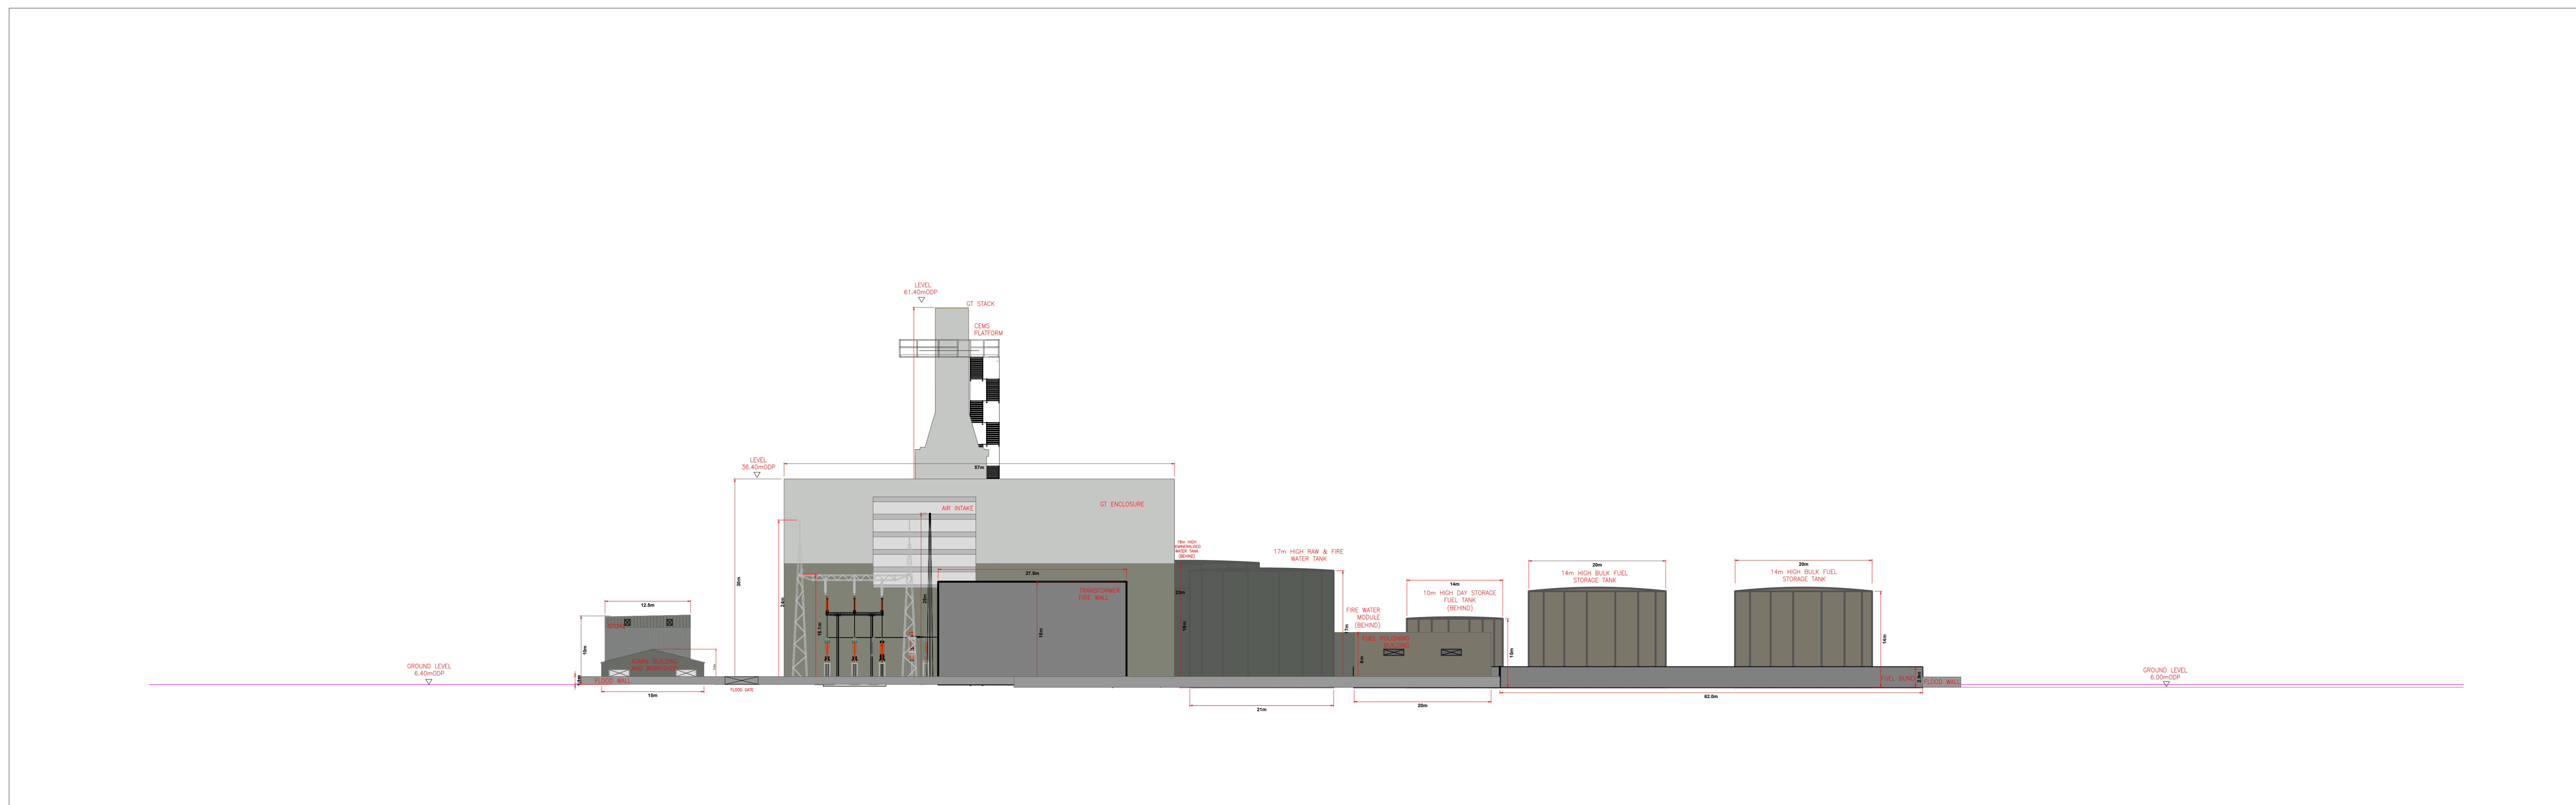


This drawing has been prepared for the use of AECOM's client. It may not be used, modified, reproduced or relied upon by third parties, except as agreed by AECOM or as required by law. AECOM accepts no responsibility, and denies any liability, whatsoever, to any party that uses or relies on this drawing without AECOM's express written consent. Do not scale this document. All measurements must be obtained from the stated dimensions.

# ELEVATION C-C

SCALE 1:200

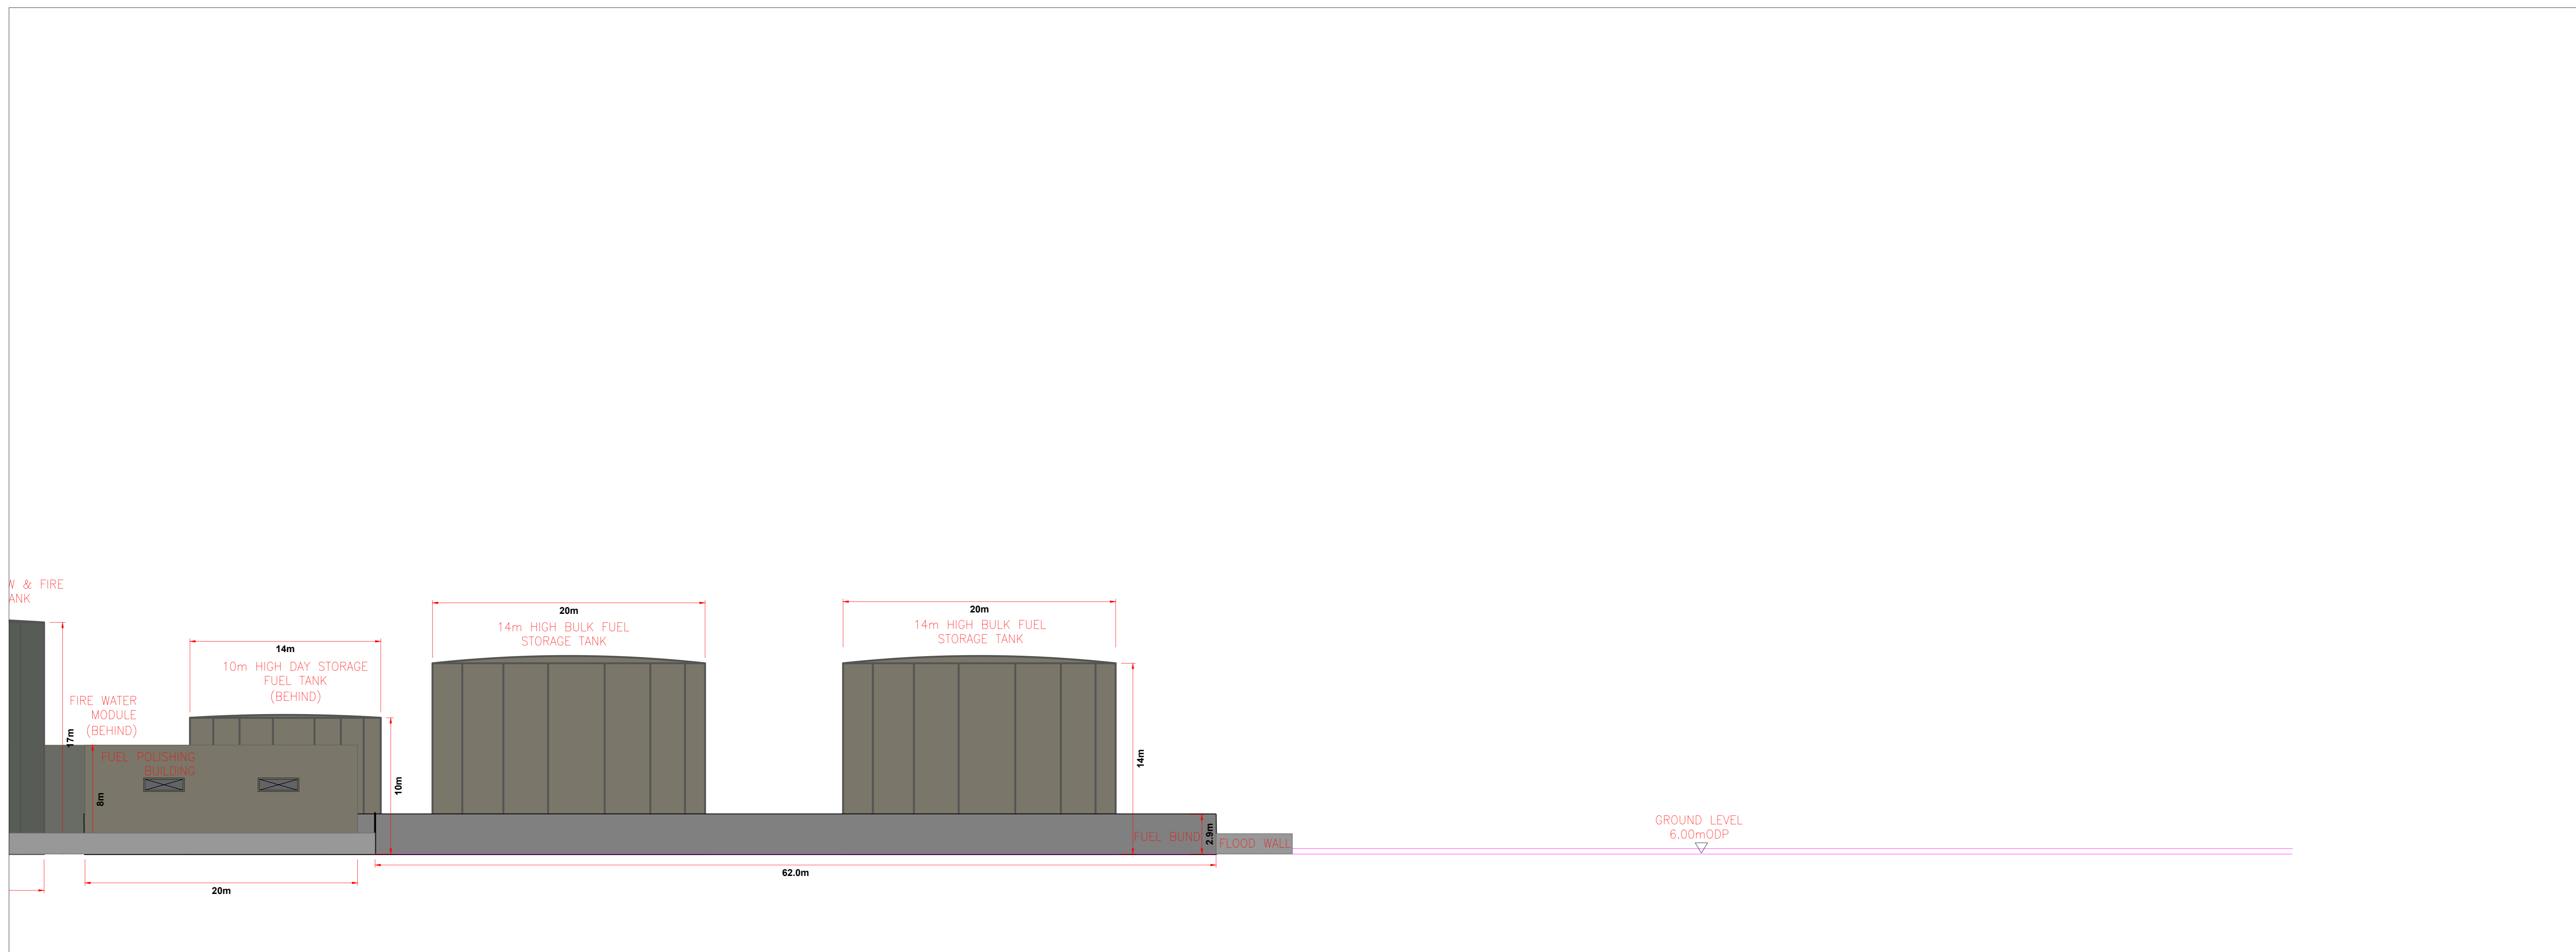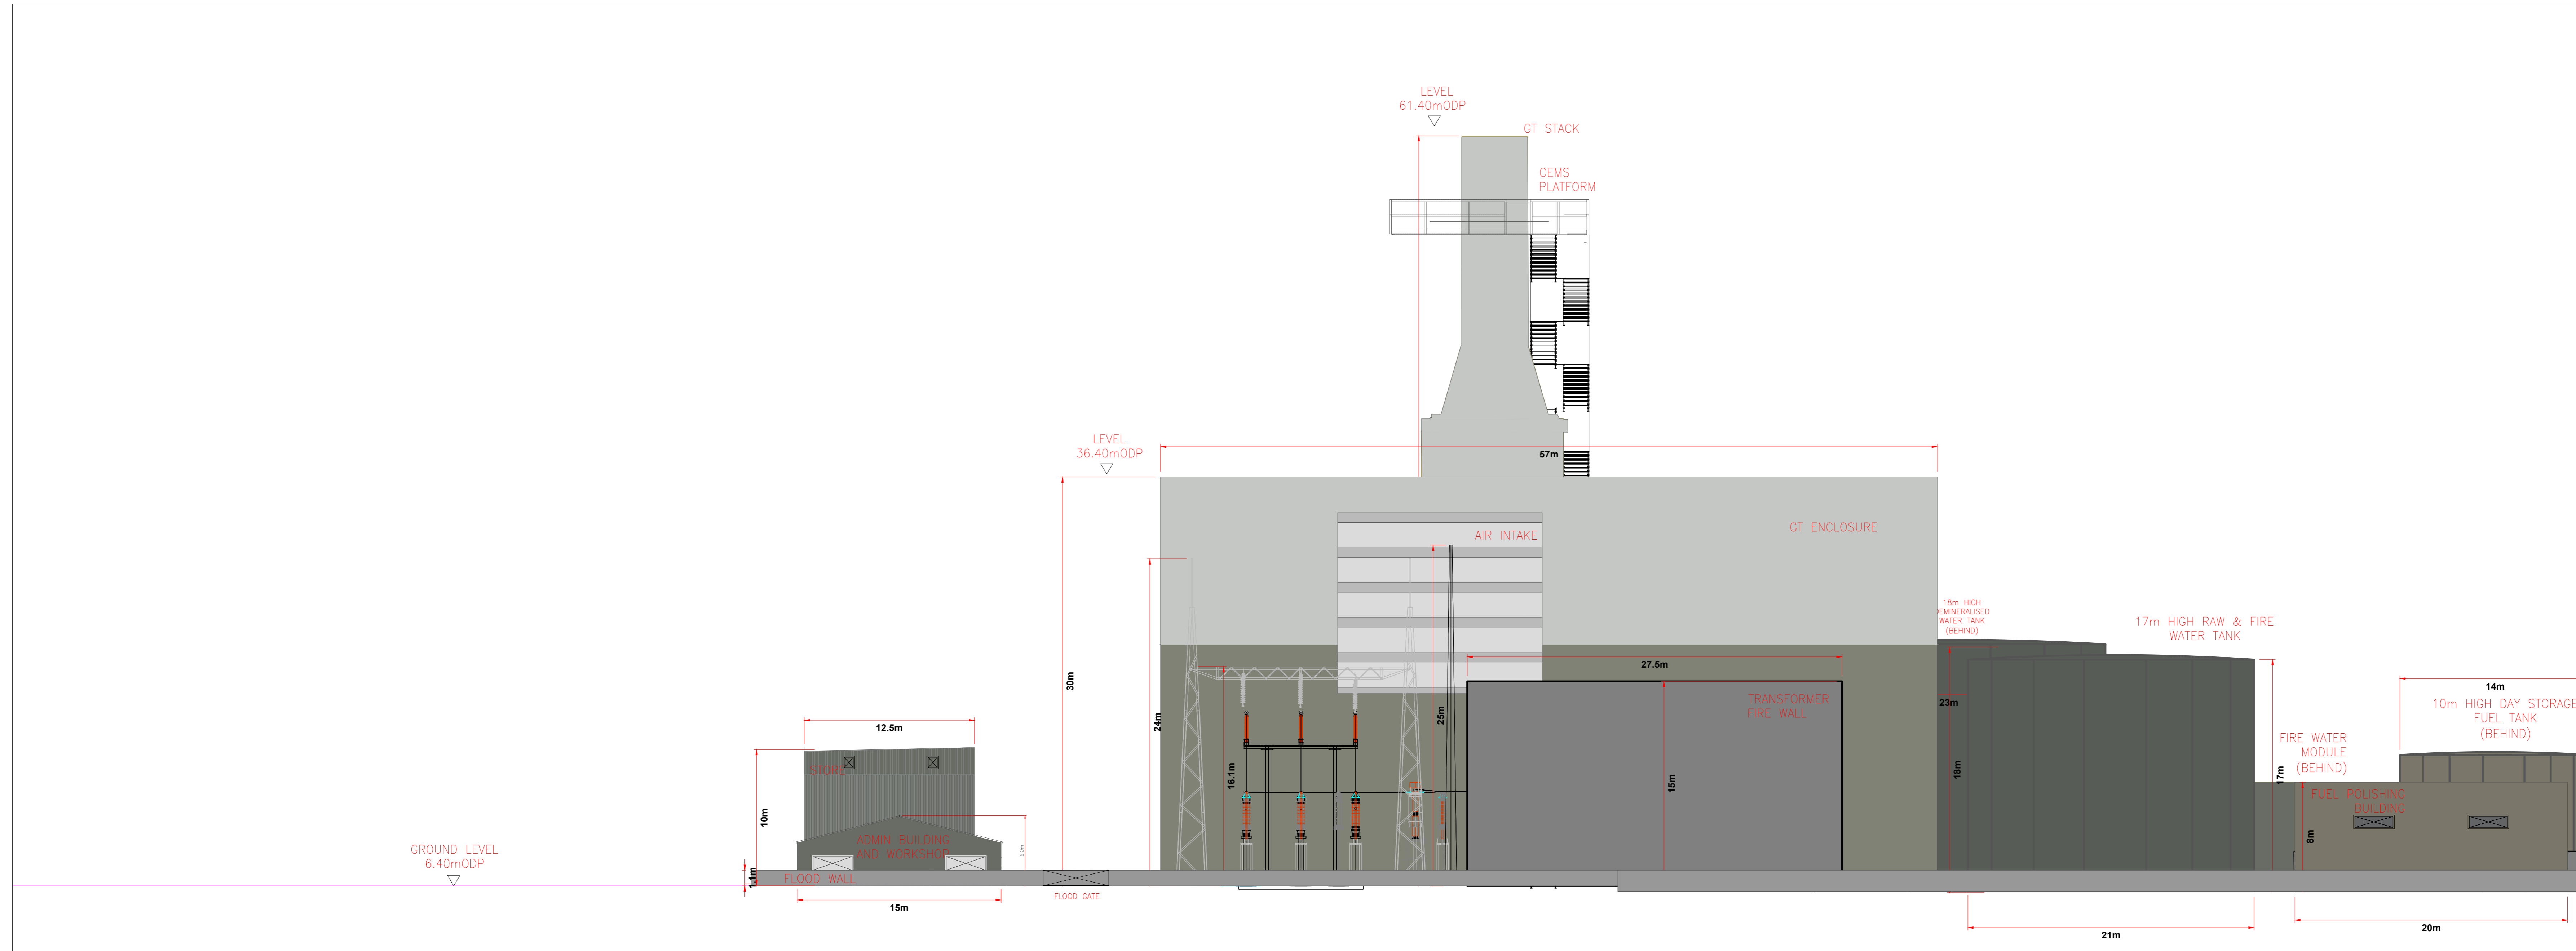

- NOTES
1. PROPOSED ELEVATIONS ARE RELATIVE TO ORDNANCE DATUM POOLBEG
  2. TO BE PRINTED AT A0

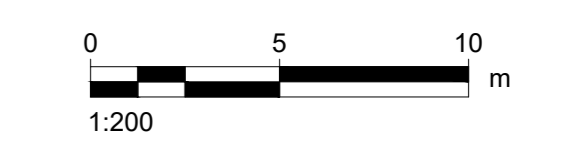

DRAWN BY  
 CONOR COONEY

ISSUE/REVISION		
I/R	DATE	DESCRIPTION
B	22/11/2023	FOR PLANNING
A	03/10/2023	FOR COMMENT

PROJECT NUMBER  
 60695232


SHEET TITLE  
 Proposed Site Elevations  
 Elevation C-C  
 Sheet 7 of 9

SHEET NUMBER  
 60695232-TBT-DR-002B

This drawing has been prepared for the use of AECOM's client. It may not be used, modified, reproduced or relied upon by third parties, except as agreed by AECOM or as required by law. AECOM accepts no responsibility, and denies any liability, whatsoever, to any party that uses or relies on this drawing without AECOM's express, written consent. Do not scale this document. All measurements must be obtained from the stated dimensions.

## ELEVATION D-D

SCALE 1:400

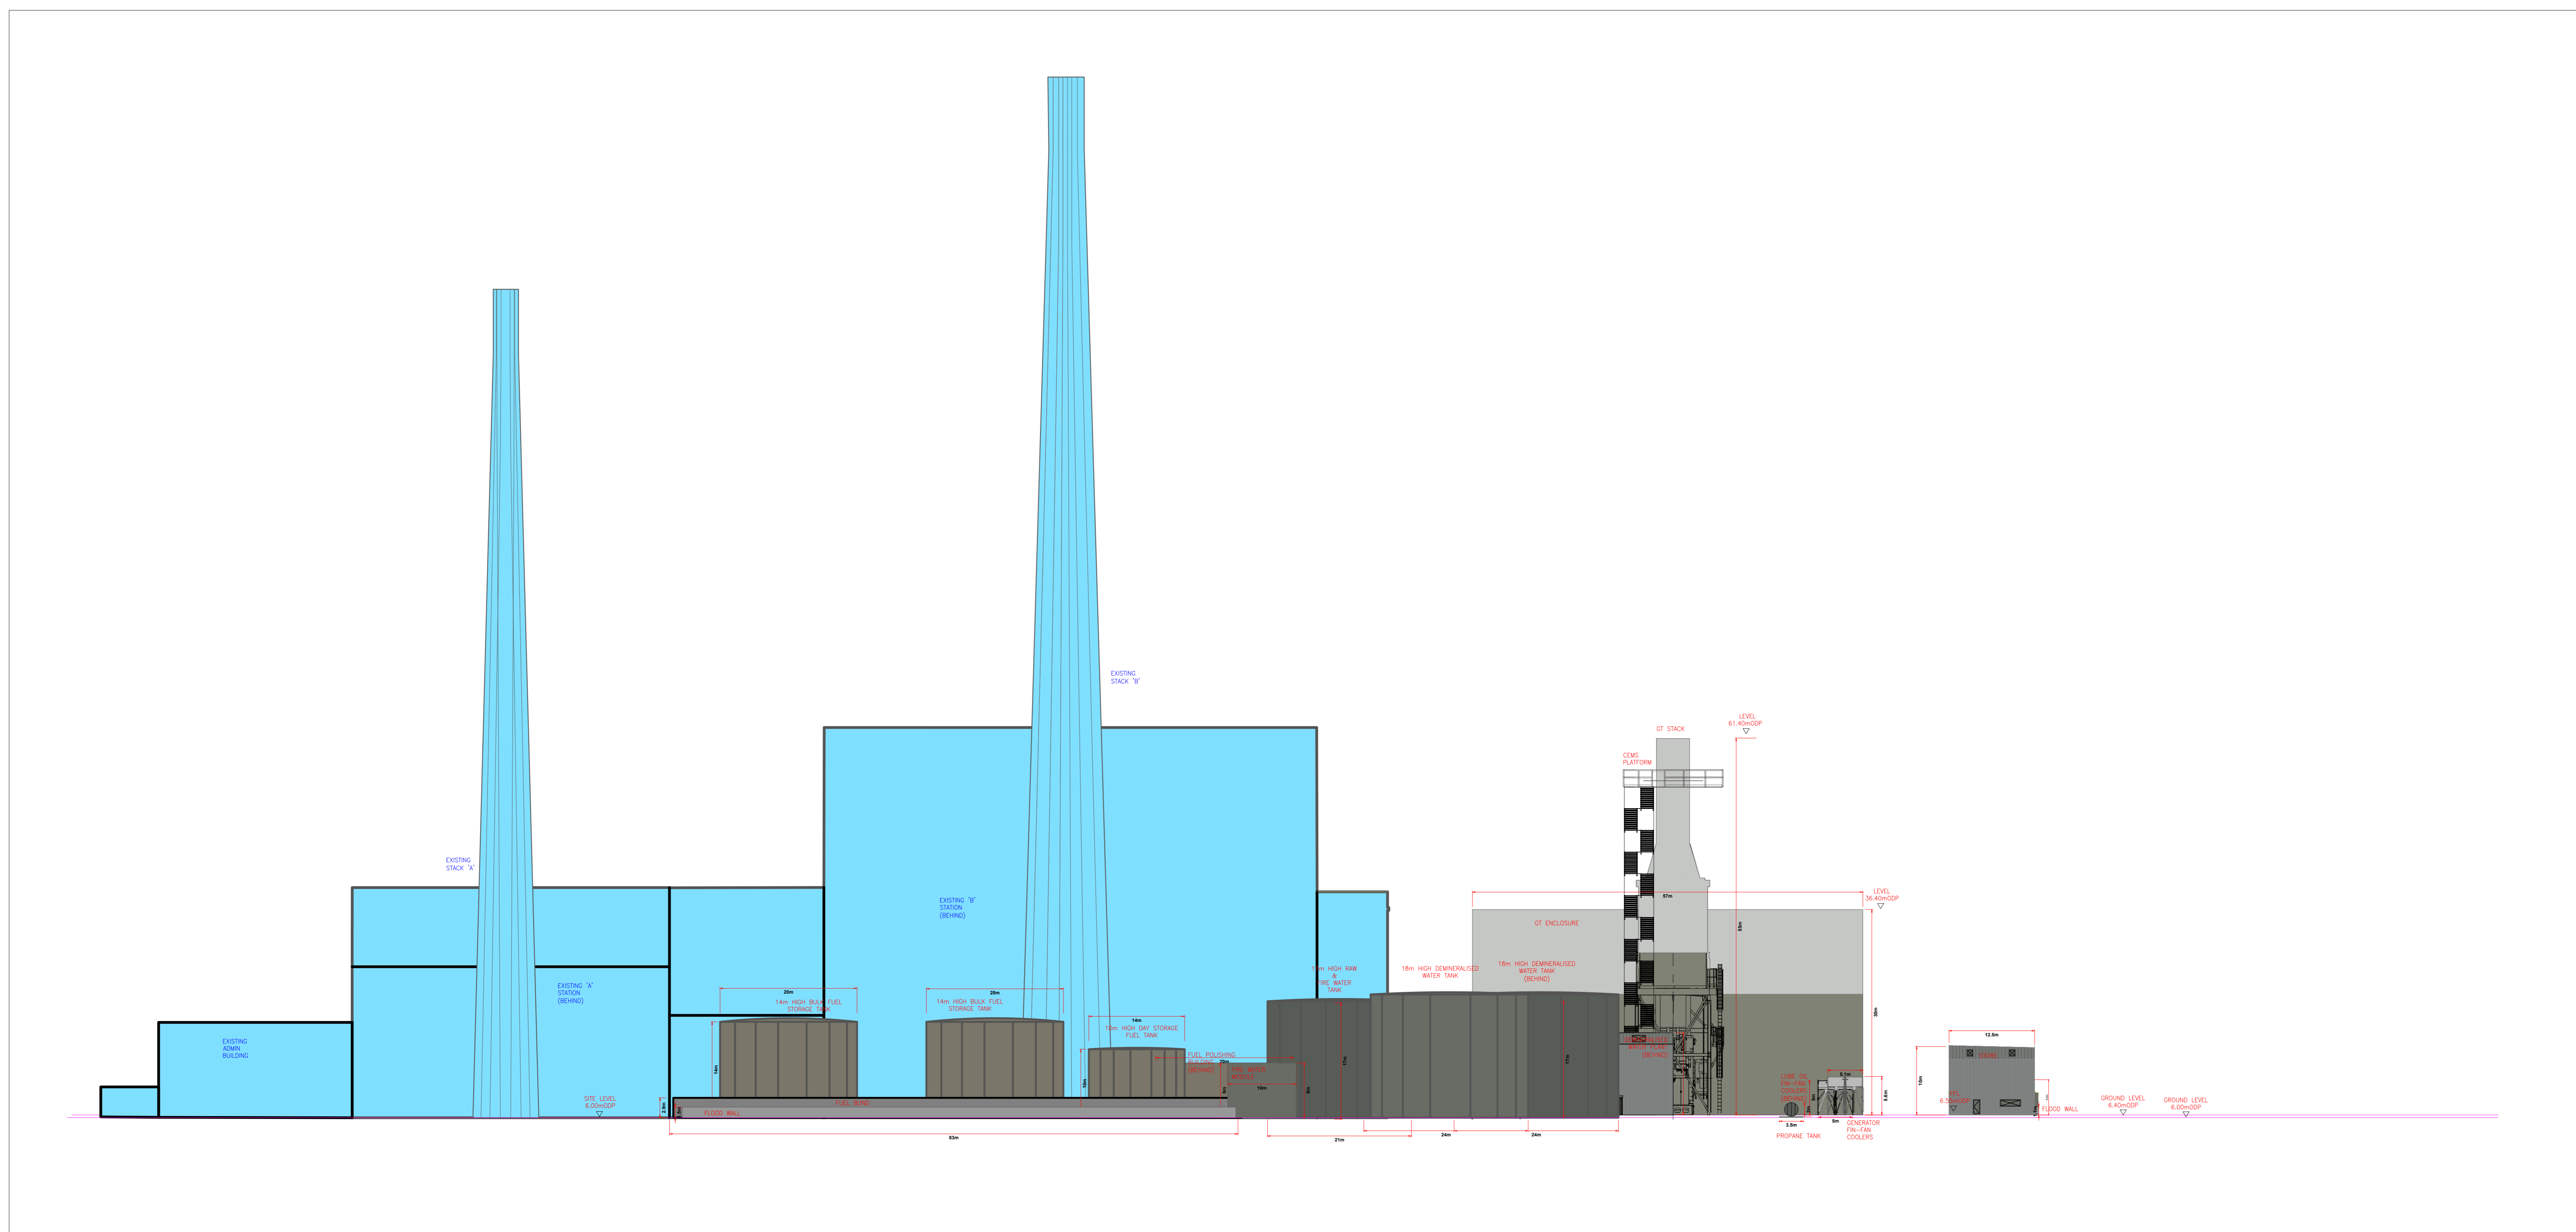

- NOTES**
- PROPOSED ELEVATIONS ARE RELATIVE TO ORDNANCE DATUM POOLBEG
  - TO BE PRINTED AT A0

**DRAWN BY**  
 CONOR COONEY

**ISSUE/REVISION**

I/R	DATE	DESCRIPTION
B	22/11/2023	FOR PLANNING
A	03/10/2023	FOR COMMENT

**PROJECT NUMBER**  
 60695232

**SHEET TITLE**  
 Proposed Site Elevations  
 Elevation D-D  
 Sheet 8 of 9



**SHEET NUMBER**  
 60695232-TBT-DR-002B

This drawing has been prepared for the use of AECOM's client. It may not be used, modified, reproduced or relied upon by third parties, except as agreed by AECOM or as required by law. AECOM accepts no responsibility, and denies any liability, whatsoever, to any party that uses or relies on this drawing without AECOM's express written consent. Do not scale this document. All measurements must be obtained from the stated dimensions.




# ELEVATION D-D

SCALE 1:200

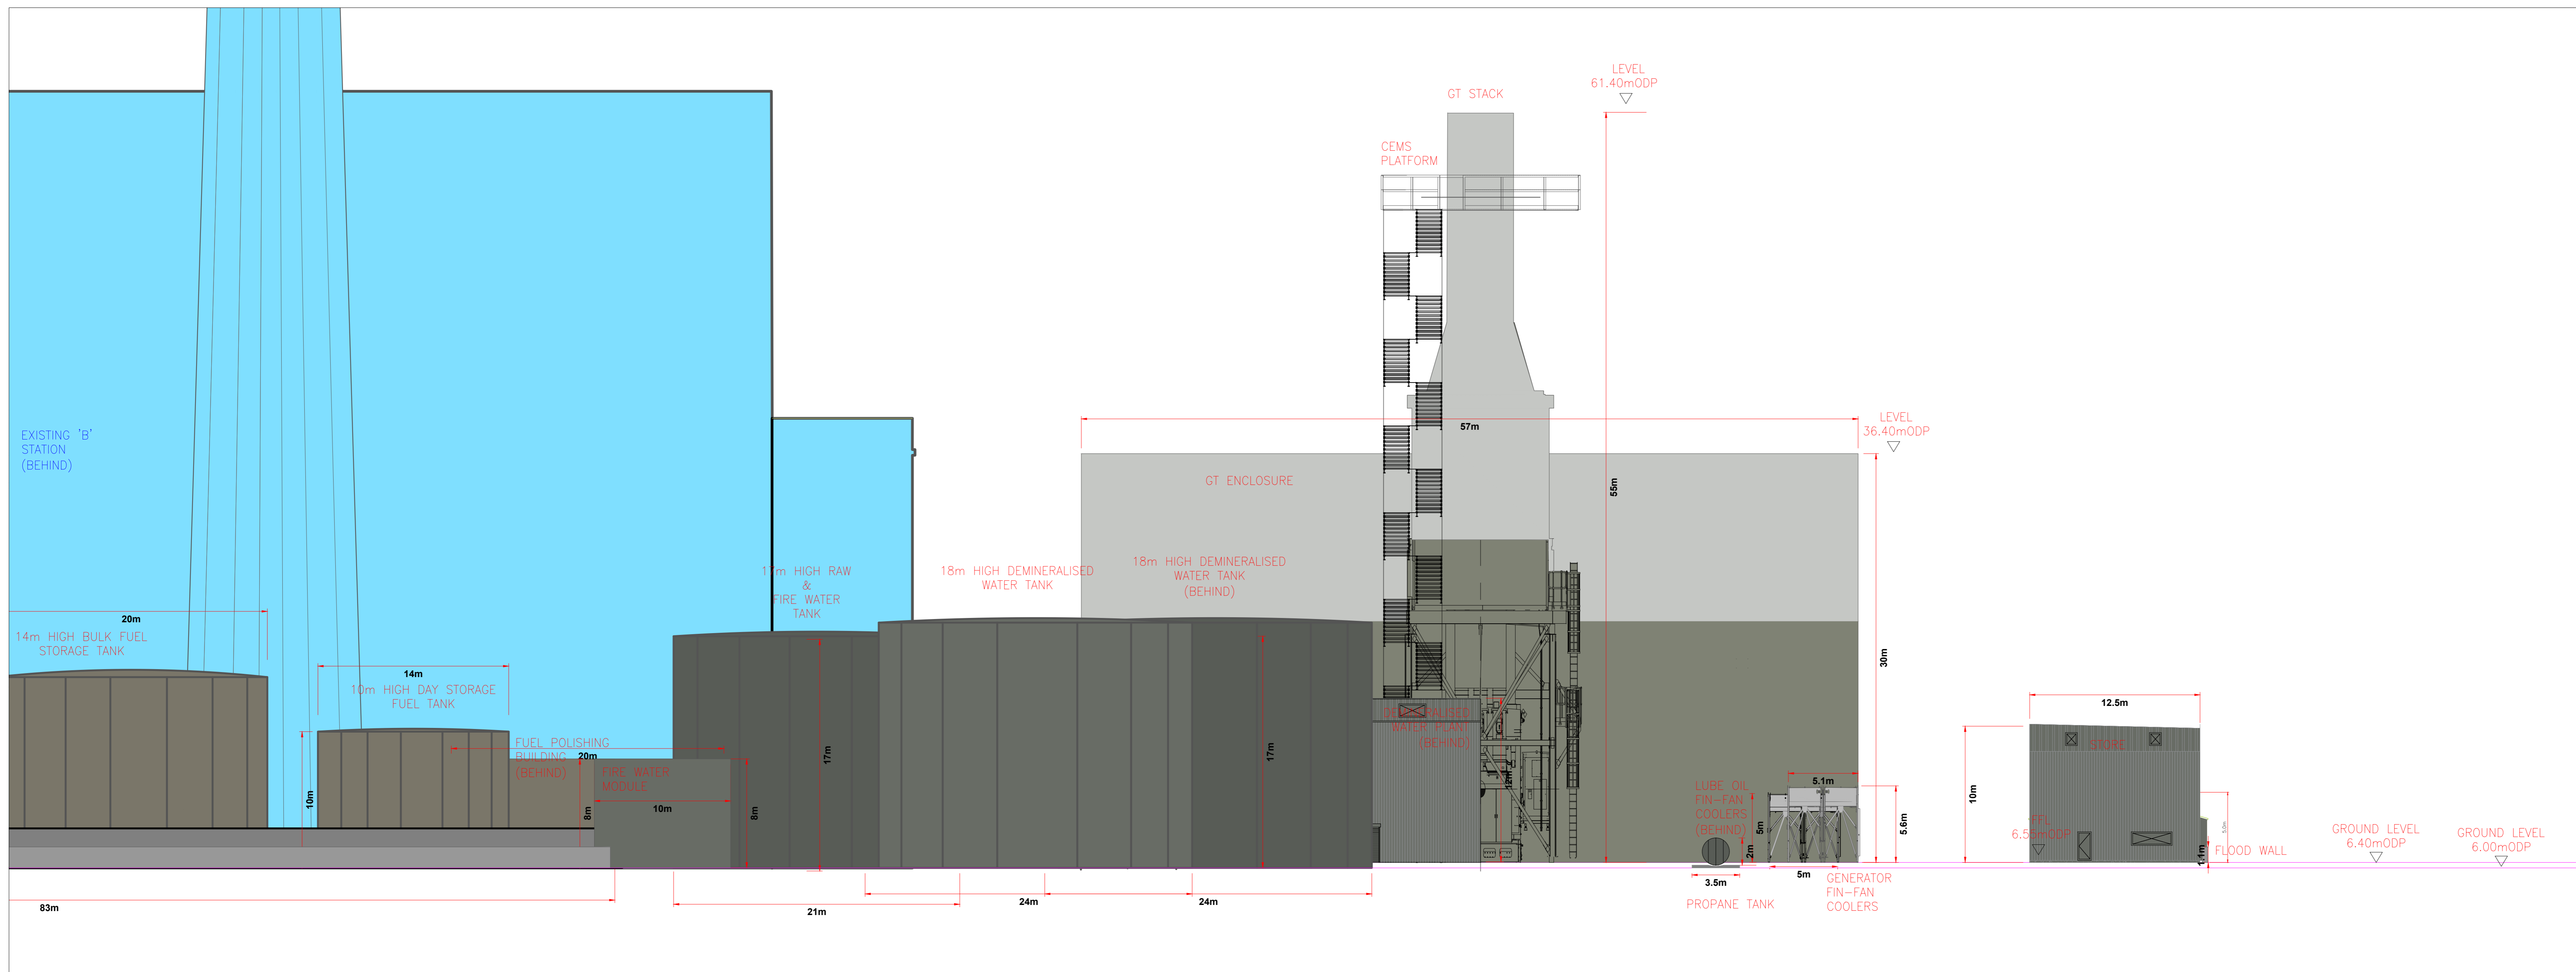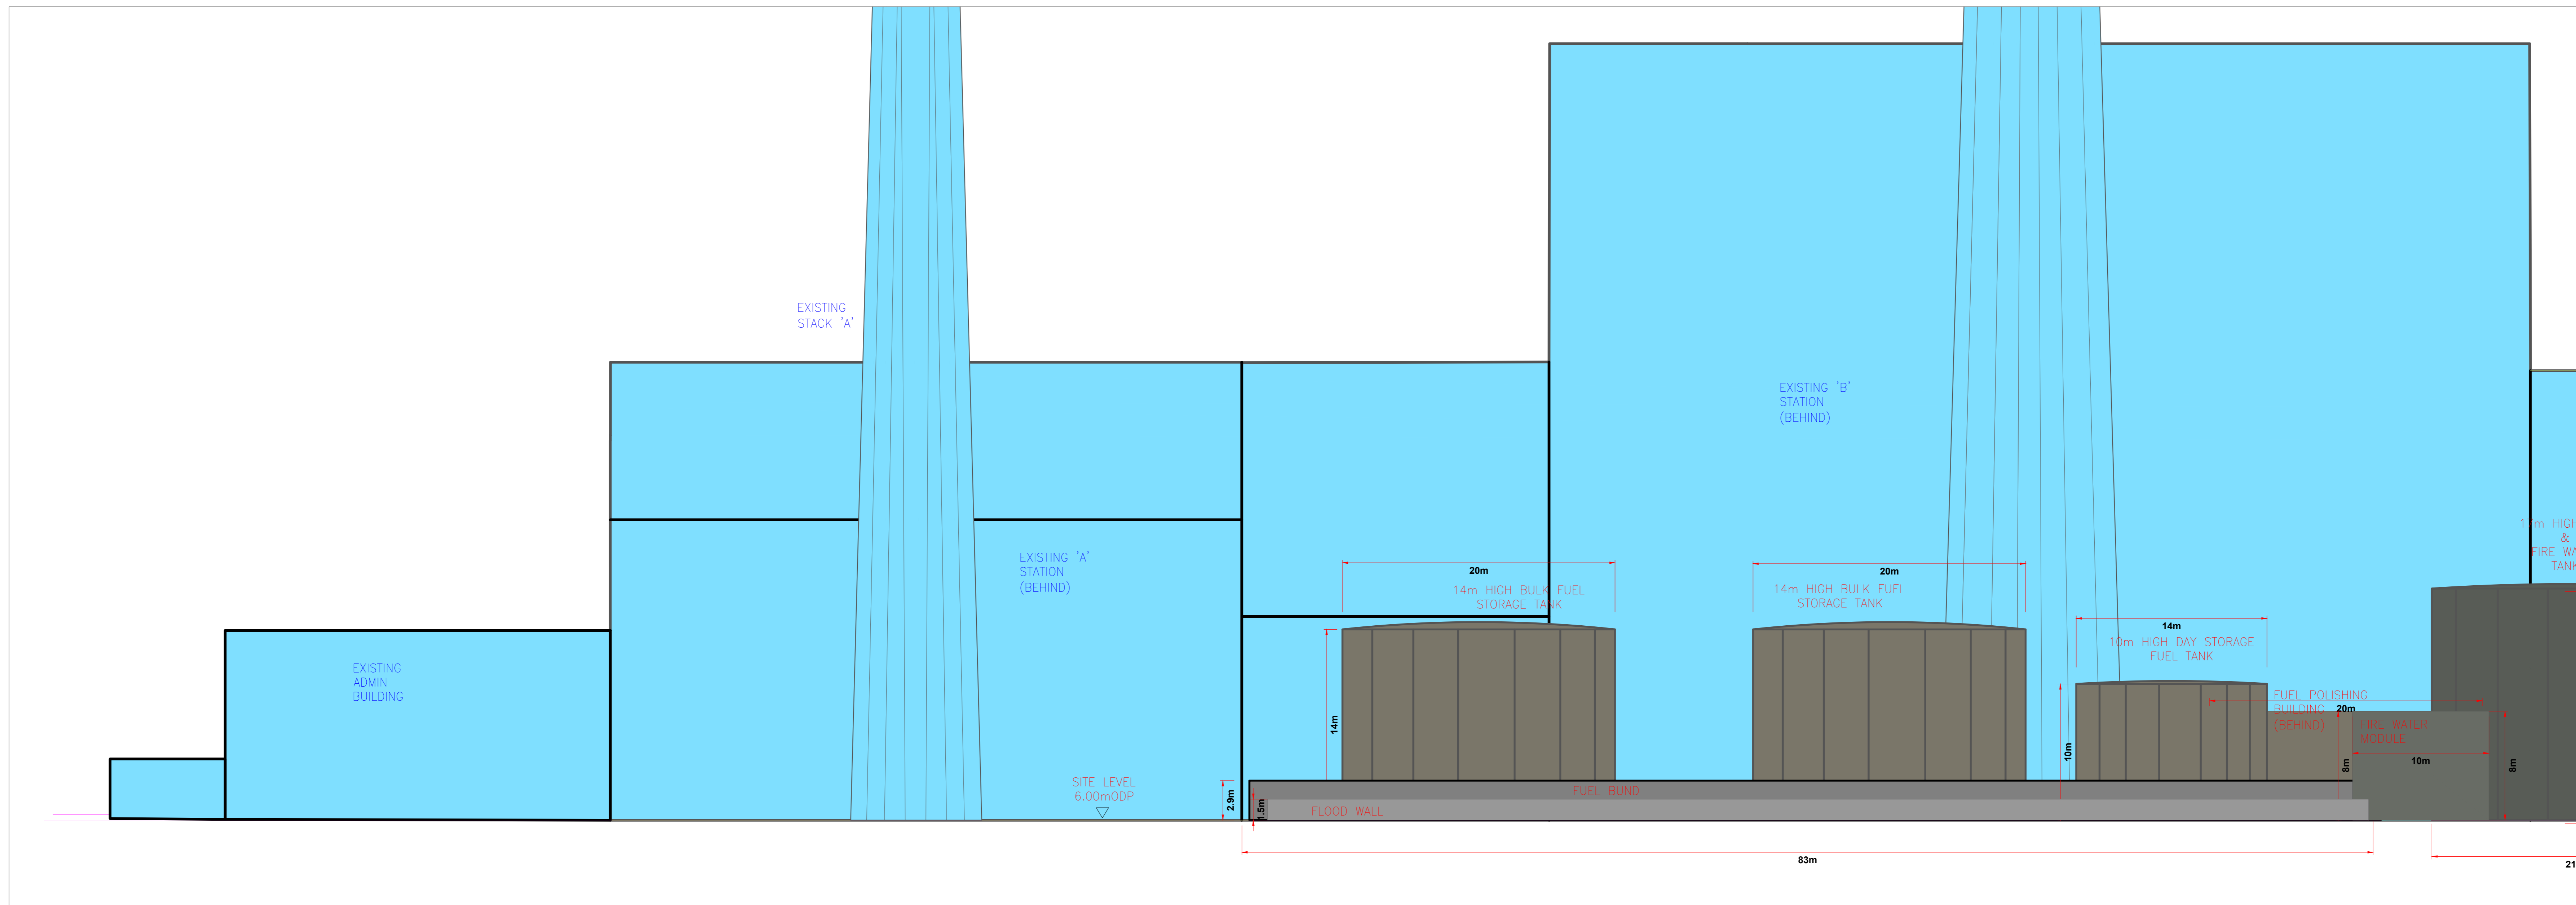

- NOTES
1. PROPOSED ELEVATIONS ARE RELATIVE TO ORDNANCE DATUM POOLBEG
  2. TO BE PRINTED AT A0

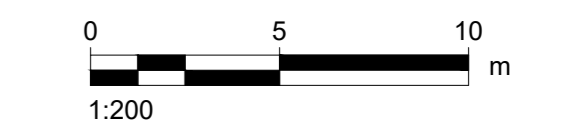

DRAWN BY  
 CONOR COONEY

ISSUE/REVISION

NO	DATE	DESCRIPTION
B	22/11/2023	FOR PLANNING
A	03/10/2023	FOR COMMENT
I/R	DATE	DESCRIPTION

PROJECT NUMBER  
 60695232

SHEET TITLE  
 Proposed Site Elevations  
 Elevation D-D  
 Sheet 9 of 9

SHEET NUMBER  
 60695232-TBT-DR-002B

This drawing has been prepared for the use of AECOM's client. It may not be used, modified, reproduced or relied upon by third parties, except as agreed by AECOM or as required by law. AECOM accepts no responsibility, and denies any liability, whatsoever, to any party that uses or relies on this drawing without AECOM's express written consent. Do not scale this document. All measurements must be obtained from the stated dimensions.